


# ' C L E M E N T J . Z A B L O C K I V A M E D I C A L C E N T E R '

5000 W. NATIONAL AVE.  
MILWAUKEE, WI

111 RENOVATE SOUTH ENTRANCE  
PROJECT NO.: 695-12-101SCP

## CAMPUS MAP

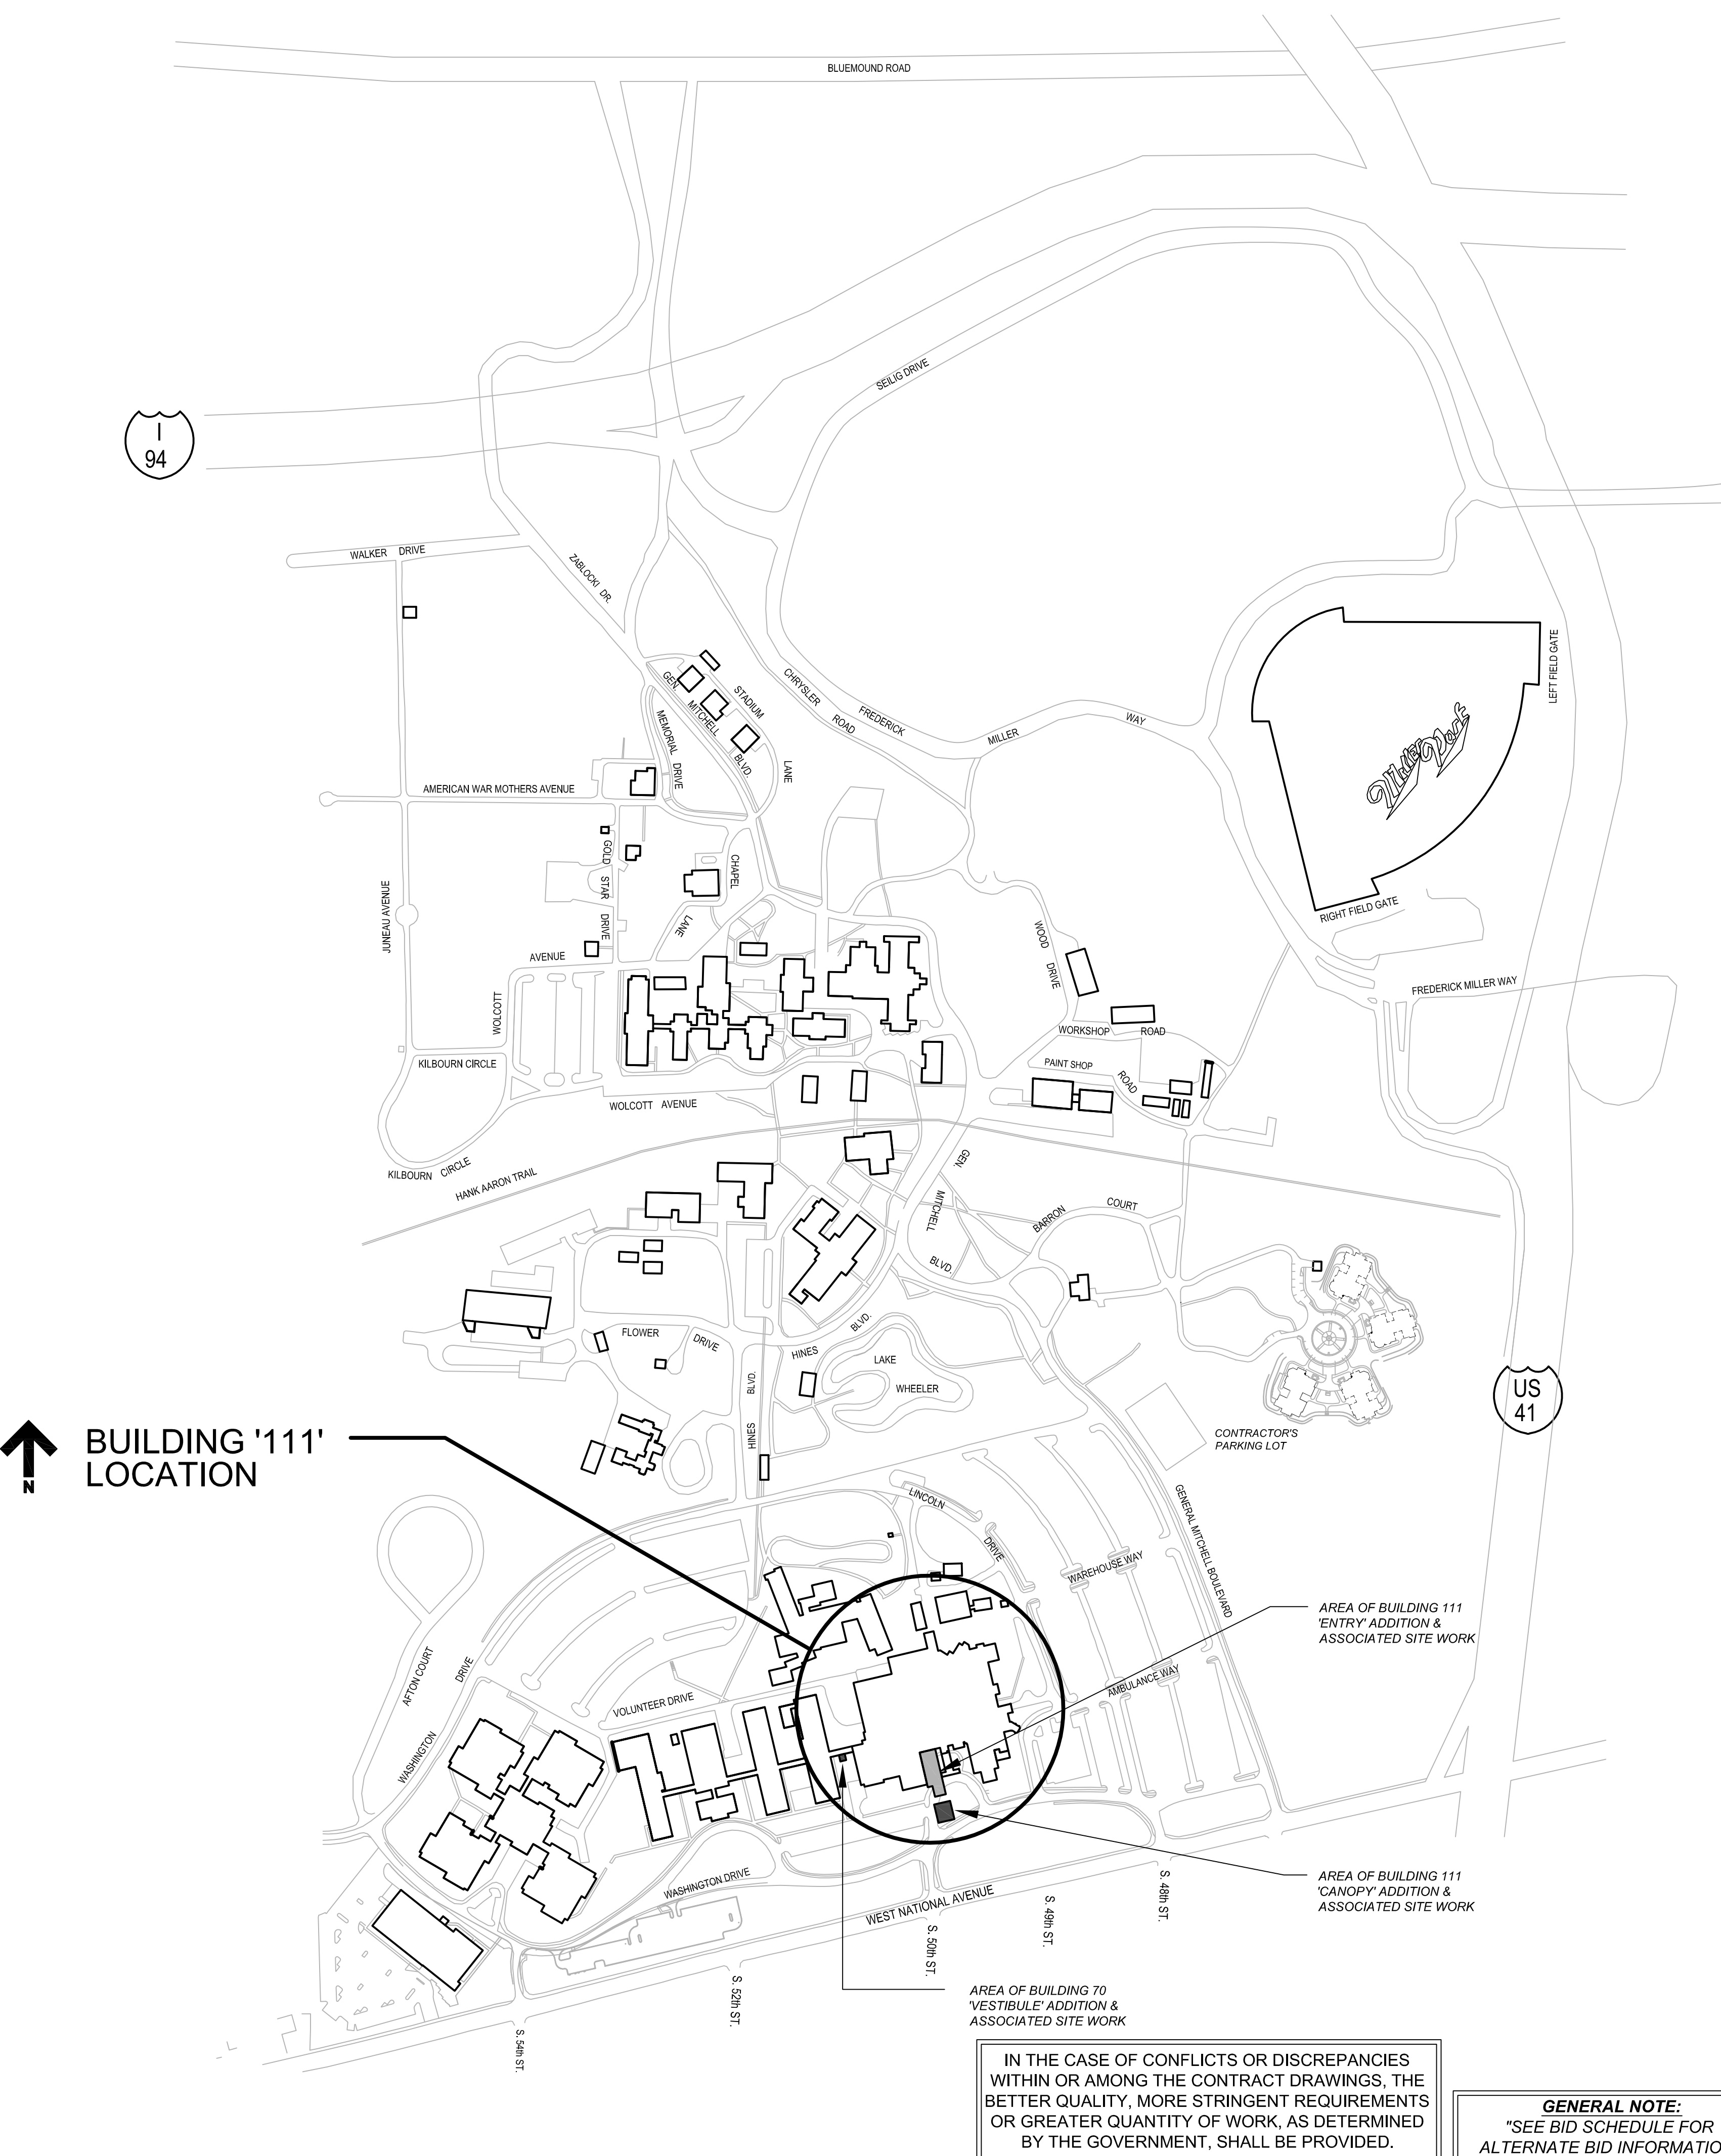

## PROJECT TEAM

### PROJECT LEADER/STRUCTURAL ENGINEER

**CHEQUAMEGON BAY GROUP, INC.**  
**ASHLAND, WI**  
211 6TH STREET WEST  
ASHLAND, WI 54806  
PHONE: (715) 682-6004  
FAX: (715) 682-6025  
**MILWAUKEE, WI**  
933 N. MAYFAIR RD.,  
SUITE 300  
MILWAUKEE, WI 53208  
PHONE: (414) 258-8004  
FAX: (414) 258-8154

### CIVIL

**CHEQUAMEGON BAY GROUP, INC.**  
**ASHLAND, WI**  
211 6TH STREET WEST  
ASHLAND, WI 54806  
PHONE: (715) 682-6004  
FAX: (715) 682-6025  
**MILWAUKEE, WI**  
933 N. MAYFAIR RD.,  
SUITE 300  
MILWAUKEE, WI 53208  
PHONE: (414) 258-8004  
FAX: (414) 258-8154

### LANDSCAPE

**R.A. SMITH NATIONAL, INC.**  
16746 W. MILLER AVENUE RD.  
BROOKFIELD, WI 53005  
PHONE: (262) 781-1000  
FAX: (262) 781-8400

### ASBESTOS

**THE SIGMA GROUP**  
1300 WEST CANAL STREET  
MILWAUKEE, WI 53233  
PHONE: (414) 643-4000  
FAX: (414) 643-4210

### ARCHITECT

**CHEQUAMEGON BAY GROUP, INC.**  
**ASHLAND, WI**  
211 6TH STREET WEST  
ASHLAND, WI 54806  
PHONE: (715) 682-6004  
FAX: (715) 682-6025  
**MILWAUKEE, WI**  
933 N. MAYFAIR RD.,  
SUITE 300  
MILWAUKEE, WI 53208  
PHONE: (414) 258-8004  
FAX: (414) 258-8154

### FIRE PROTECTION

**RING & DuCHATEAU**  
10101 INNOVATION DRIVE, SUITE 200  
MILWAUKEE, WI 53226  
PHONE: (414) 778-1700  
FAX: (414) 778-2380

### PLUMBING

**RING & DuCHATEAU**  
10101 INNOVATION DRIVE, SUITE 200  
MILWAUKEE, WI 53226  
PHONE: (414) 778-1700  
FAX: (414) 778-2380


### HVAC

**RING & DuCHATEAU**  
10101 INNOVATION DRIVE, SUITE 200  
MILWAUKEE, WI 53226  
PHONE: (414) 778-1700  
FAX: (414) 778-2380

### ELECTRICAL

**RING & DuCHATEAU**  
10101 INNOVATION DRIVE, SUITE 200  
MILWAUKEE, WI 53226  
PHONE: (414) 778-1700  
FAX: (414) 778-2380

## LOCATION MAP

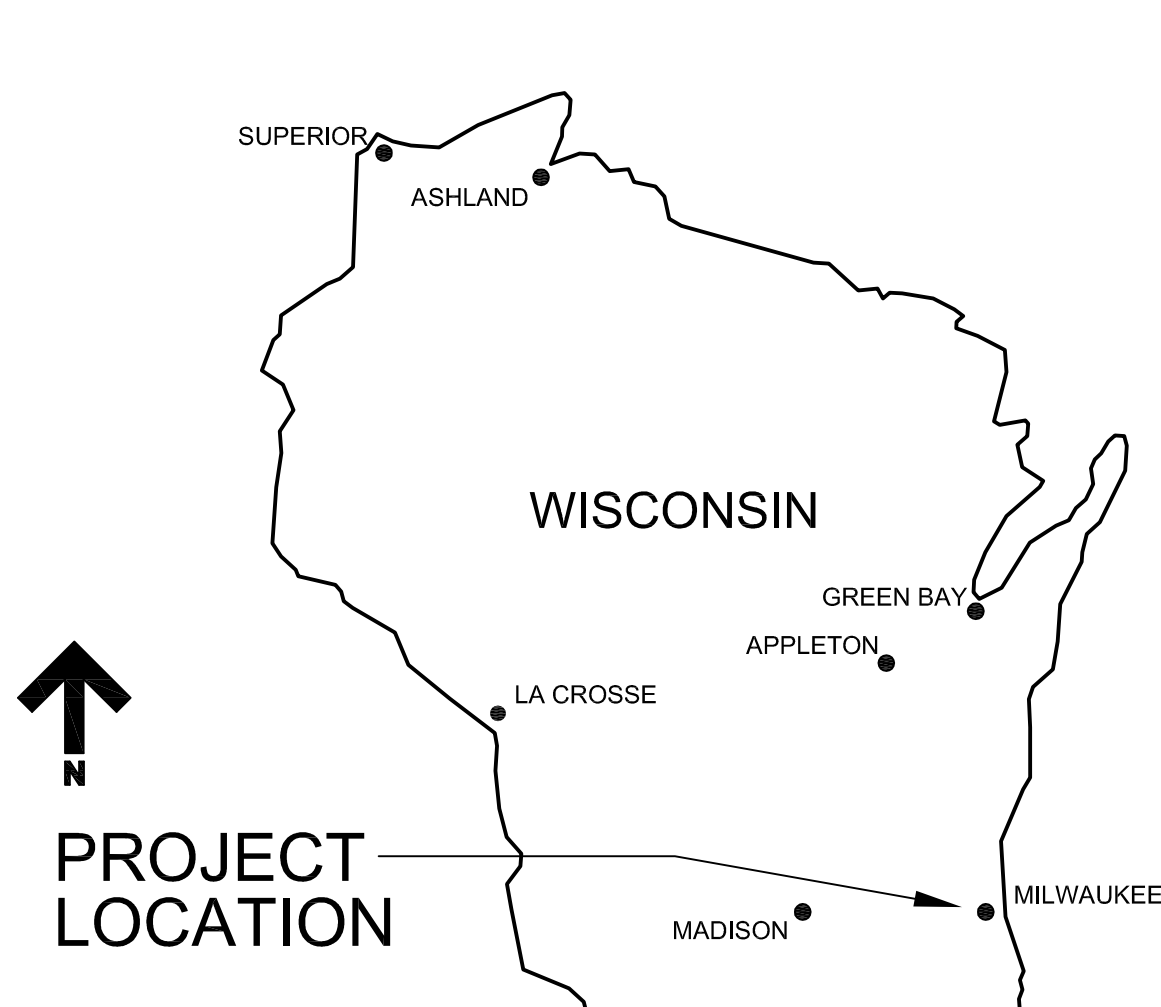

## SHEET INDEX


VOLUME 1 OF 2					
SHEET NO.	SHEET TITLE	ISSUED FOR FINAL SCHEM. REVIEW	ISSUED FOR 50% CONST. DOCS.	ISSUED FOR 95% CONST. DOCS.	ISSUED FOR 100% CONST. DOCS.
	ISSUE DATE:	12/24/2013	2/27/2014	5/16/2014	6/23/2014
GENERAL INFORMATION/TITLE SHEETS					
G101	VOLUME 1 OF 2: TITLE SHEET, PROJECT INFORMATION, & SHEET INDEX	X	X	X	X
CIVIL DRAWINGS					
C000	CIVIL NOTES AND GENERAL INFORMATION	X	X	X	X
C100	EXISTING SITE CONDITIONS PLAN	X	X	X	X
C101	EROSION CONTROL & CONSTRUCTION FENCING PLAN		X	X	X
C102	SITE DEMOLITION PLAN		X	X	X
C103	TRAFFIC CONTROL PLAN		X	X	X
C200	NEW CONSTRUCTION SITE PLAN	X	X	X	X
C201	NEW CONSTRUCTION SITE GRADING PLAN	X	X	X	X
C202	NEW CONSTRUCTION SITE UTILITIES PLAN		X	X	X
C203	PROPOSED ROAD ALIGNMENT PLAN & PROFILES		X	X	X
C300	CIVIL DETAILS	X	X	X	X
C301	CIVIL DETAILS		X	X	X
LANDSCAPE DRAWINGS					
L100	OVERALL LANDSCAPE PLAN		X	X	X
L101	SOUTH CANOPY ENTRANCE LANDSCAPE PLAN		X	X	X
L102	BUILDING 70 - CONNECTING CORRIDOR NEW VESTIBULE ADDITION PROPOSED LANDSCAPE PLAN		X	X	X
L103	MONUMENT RELOCATION PLAN AND LANDSCAPE DETAILS		X	X	X
ASBESTOS ABATEMENT DRAWINGS					
ASB100	BUILDING 111 - LOWER LEVEL ENTRY - ASBESTOS ABATEMENT			X	X
ASB101	BUILDING 111 - FIRST FLOOR ENTRY - ASBESTOS ABATEMENT			X	X
ASB110	BUILDING 70 - CONNECTING CORRIDOR - ASBESTOS ABATEMENT			X	X
ARCHITECTURAL DRAWINGS					
A001	BUILDING 70 & 111 - GENERAL PHASING NOTES		X	X	X
A000.1	BUILDING 70 & 111 - INFECTION CONTROL PLANS		X	X	X
A001	BUILDING 70 - CONSTRUCTION PHASING PLANS			X	X
A002	BUILDING 111 - CONSTRUCTION PHASING PLANS			X	X
A003	BUILDING 70 & 111 - GENERAL NOTES & ABBREVIATIONS		X	X	X
A010	BUILDING 111 - LOWER LEVEL & FIRST FLOOR 'ENTRY' & 'CANOPY' LIFE SAFETY PLANS		X	X	X
AD100	BUILDING 111 - LOWER LEVEL 'ENTRY' DEMOLITION PLAN		X	X	X
A100	BUILDING 111 - LOWER LEVEL 'ENTRY' & 'CANOPY' FLOOR PLANS	X	X	X	X
AD101	BUILDING 111 - FIRST FLOOR 'ENTRY' DEMOLITION PLAN		X	X	X
A101	BUILDING 111 - FIRST FLOOR 'ENTRY' & 'CANOPY' FLOOR PLANS		X	X	X
A102	BUILDING 111 - FIRST FLOOR 'ENTRY' & 'CANOPY' CLEARSTORY PLANS		X	X	X
A110	BUILDING 70 - CONNECTING CORRIDOR VESTIBULE ADDITION		X	X	X
A110.1	BUILDING 70 - CONNECTING CORRIDOR VESTIBULE ADDITION SITE WORK			X	X
A201	BUILDING 111 - FIRST FLOOR 'ENTRY' & 'CANOPY' ROOF PLANS		X	X	X
A202	BUILDING 111 - FIRST FLOOR 'ENTRY' & 'CANOPY' CLEARSTORY ROOF PLANS		X	X	X
A210	BUILDING 70 - CONNECTING CORRIDOR ROOF PLAN			X	X
A300	BUILDING 111 - LOWER LEVEL 'ENTRY' REFLECTED CEILING PLAN		X	X	X
A301	BUILDING 111 - FIRST FLOOR 'ENTRY' & 'CANOPY' REFLECTED CEILING PLANS		X	X	X
A310	BUILDING 70 - CONNECTING CORRIDOR REFLECTED CEILING PLAN		X	X	X
A400	BUILDING 111 - 'ENTRY' & 'CANOPY' BUILDING ELEVATIONS	X	X	X	X
A500	BUILDING 111 - 'ENTRY' & 'CANOPY' WALL SECTIONS		X	X	X
A501	BUILDING 111 - 'ENTRY' & 'CANOPY' WALL SECTIONS		X	X	X
A502	BUILDING 111 - 'ENTRY' & 'CANOPY' WALL SECTIONS			X	X
A503	BUILDING 111 - 'ENTRY' & 'CANOPY' ENLARGED DETAILS			X	X
A510	BUILDING 111 - 'ENTRY' & 'CANOPY' ENLARGED STAIR PLANS & SECTIONS			X	X
A800	BUILDING 111 - INTERIOR ENLARGED PLANS & DETAILS		X	X	X
A801	BUILDING 111 - INTERIOR ENLARGED PLANS & DETAILS		X	X	X
A802	BUILDING 111 - INTERIOR ENLARGED INTERIOR ELEVATIONS & DETAILS			X	X
A810	DOOR SCHEDULE, DOOR & FRAME TYPES, & DETAILS		X	X	X
A811	ALUMINUM WINDOW FRAME ELEVATIONS		X	X	X
A812	ALUMINUM WINDOW FRAME ELEVATIONS		X	X	X
A900	BUILDING 111 - LOWER LEVEL 'ENTRY' FLOOR FINISH PLAN			X	X
A900.1	BUILDING 111 - LOWER LEVEL 'ENTRY' WALL FINISH PLAN			X	X
A901	BUILDING 111 - FIRST FLOOR 'ENTRY' & 'CANOPY' FLOOR FINISH PLANS			X	X
A901.1	BUILDING 111 - FIRST FLOOR 'ENTRY' & 'CANOPY' WALL FINISH PLANS			X	X
MODULAR SYSTEMS FURNITURE DRAWINGS					
IN101	BUILDING 111 - FIRST FLOOR 'ENTRY' & 'CANOPY' FURNITURE FLOOR PLANS			X	X
IN800	BUILDING 111 - FIRST FLOOR 'ENTRY' & 'CANOPY' FURNITURE ELEVATIONS			X	X
IN810	BUILDING 111 - FIRST FLOOR 'ENTRY' & 'CANOPY' FURNITURE SCHEDULES			X	X
STRUCTURAL DRAWINGS					
S000	STRUCTURAL GENERAL NOTES		X	X	X
S100	BUILDING 111 - 'ENTRY' & 'CANOPY' FOUNDATION & FLOOR FRAMING PLANS		X	X	X
S110	BUILDING 70 - CONNECTING CORRIDOR VESTIBULE ADDITION FOUNDATION & FLOOR FRAMING PLANS		X	X	X
S201	BUILDING 111 - 'ENTRY' & 'CANOPY' ROOF FRAMING PLANS		X	X	X
S202	BUILDING 111 - 'ENTRY' & 'CANOPY' CLEARSTORY ROOF FRAMING PLANS		X	X	X
S500	STRUCTURAL DETAILS		X	X	X
S501	STRUCTURAL DETAILS		X	X	X
S502	STRUCTURAL DETAILS		X	X	X
S503	STRUCTURAL DETAILS			X	X

Revisions:		Date	Dept. of Veterans Affairs Medical Center 5000 W. National Avenue Milwaukee, WI		KEY PLAN: EXISTING BLDG. 111 VESTIBULE ADDITION ENTRY CANOPY	CONSULTANTS: RING & DUCHATEAU R.A. Smith National	PROJECT LEADER/ARCHITECT: Chequamegon	Drawing Title Volume 1 of 2: Titlesheet, Project Information & Sheet Index	Project Title Building 111 - Renovate South Entry	Location Milwaukee, Wisconsin	Date June 23, 2014	Checked By: MAC	Drawn By: KJS	Project Number 695-12-101SCP Building Number 111 Drawing Number G101	Office of Facilities Management Department of Veterans Affairs
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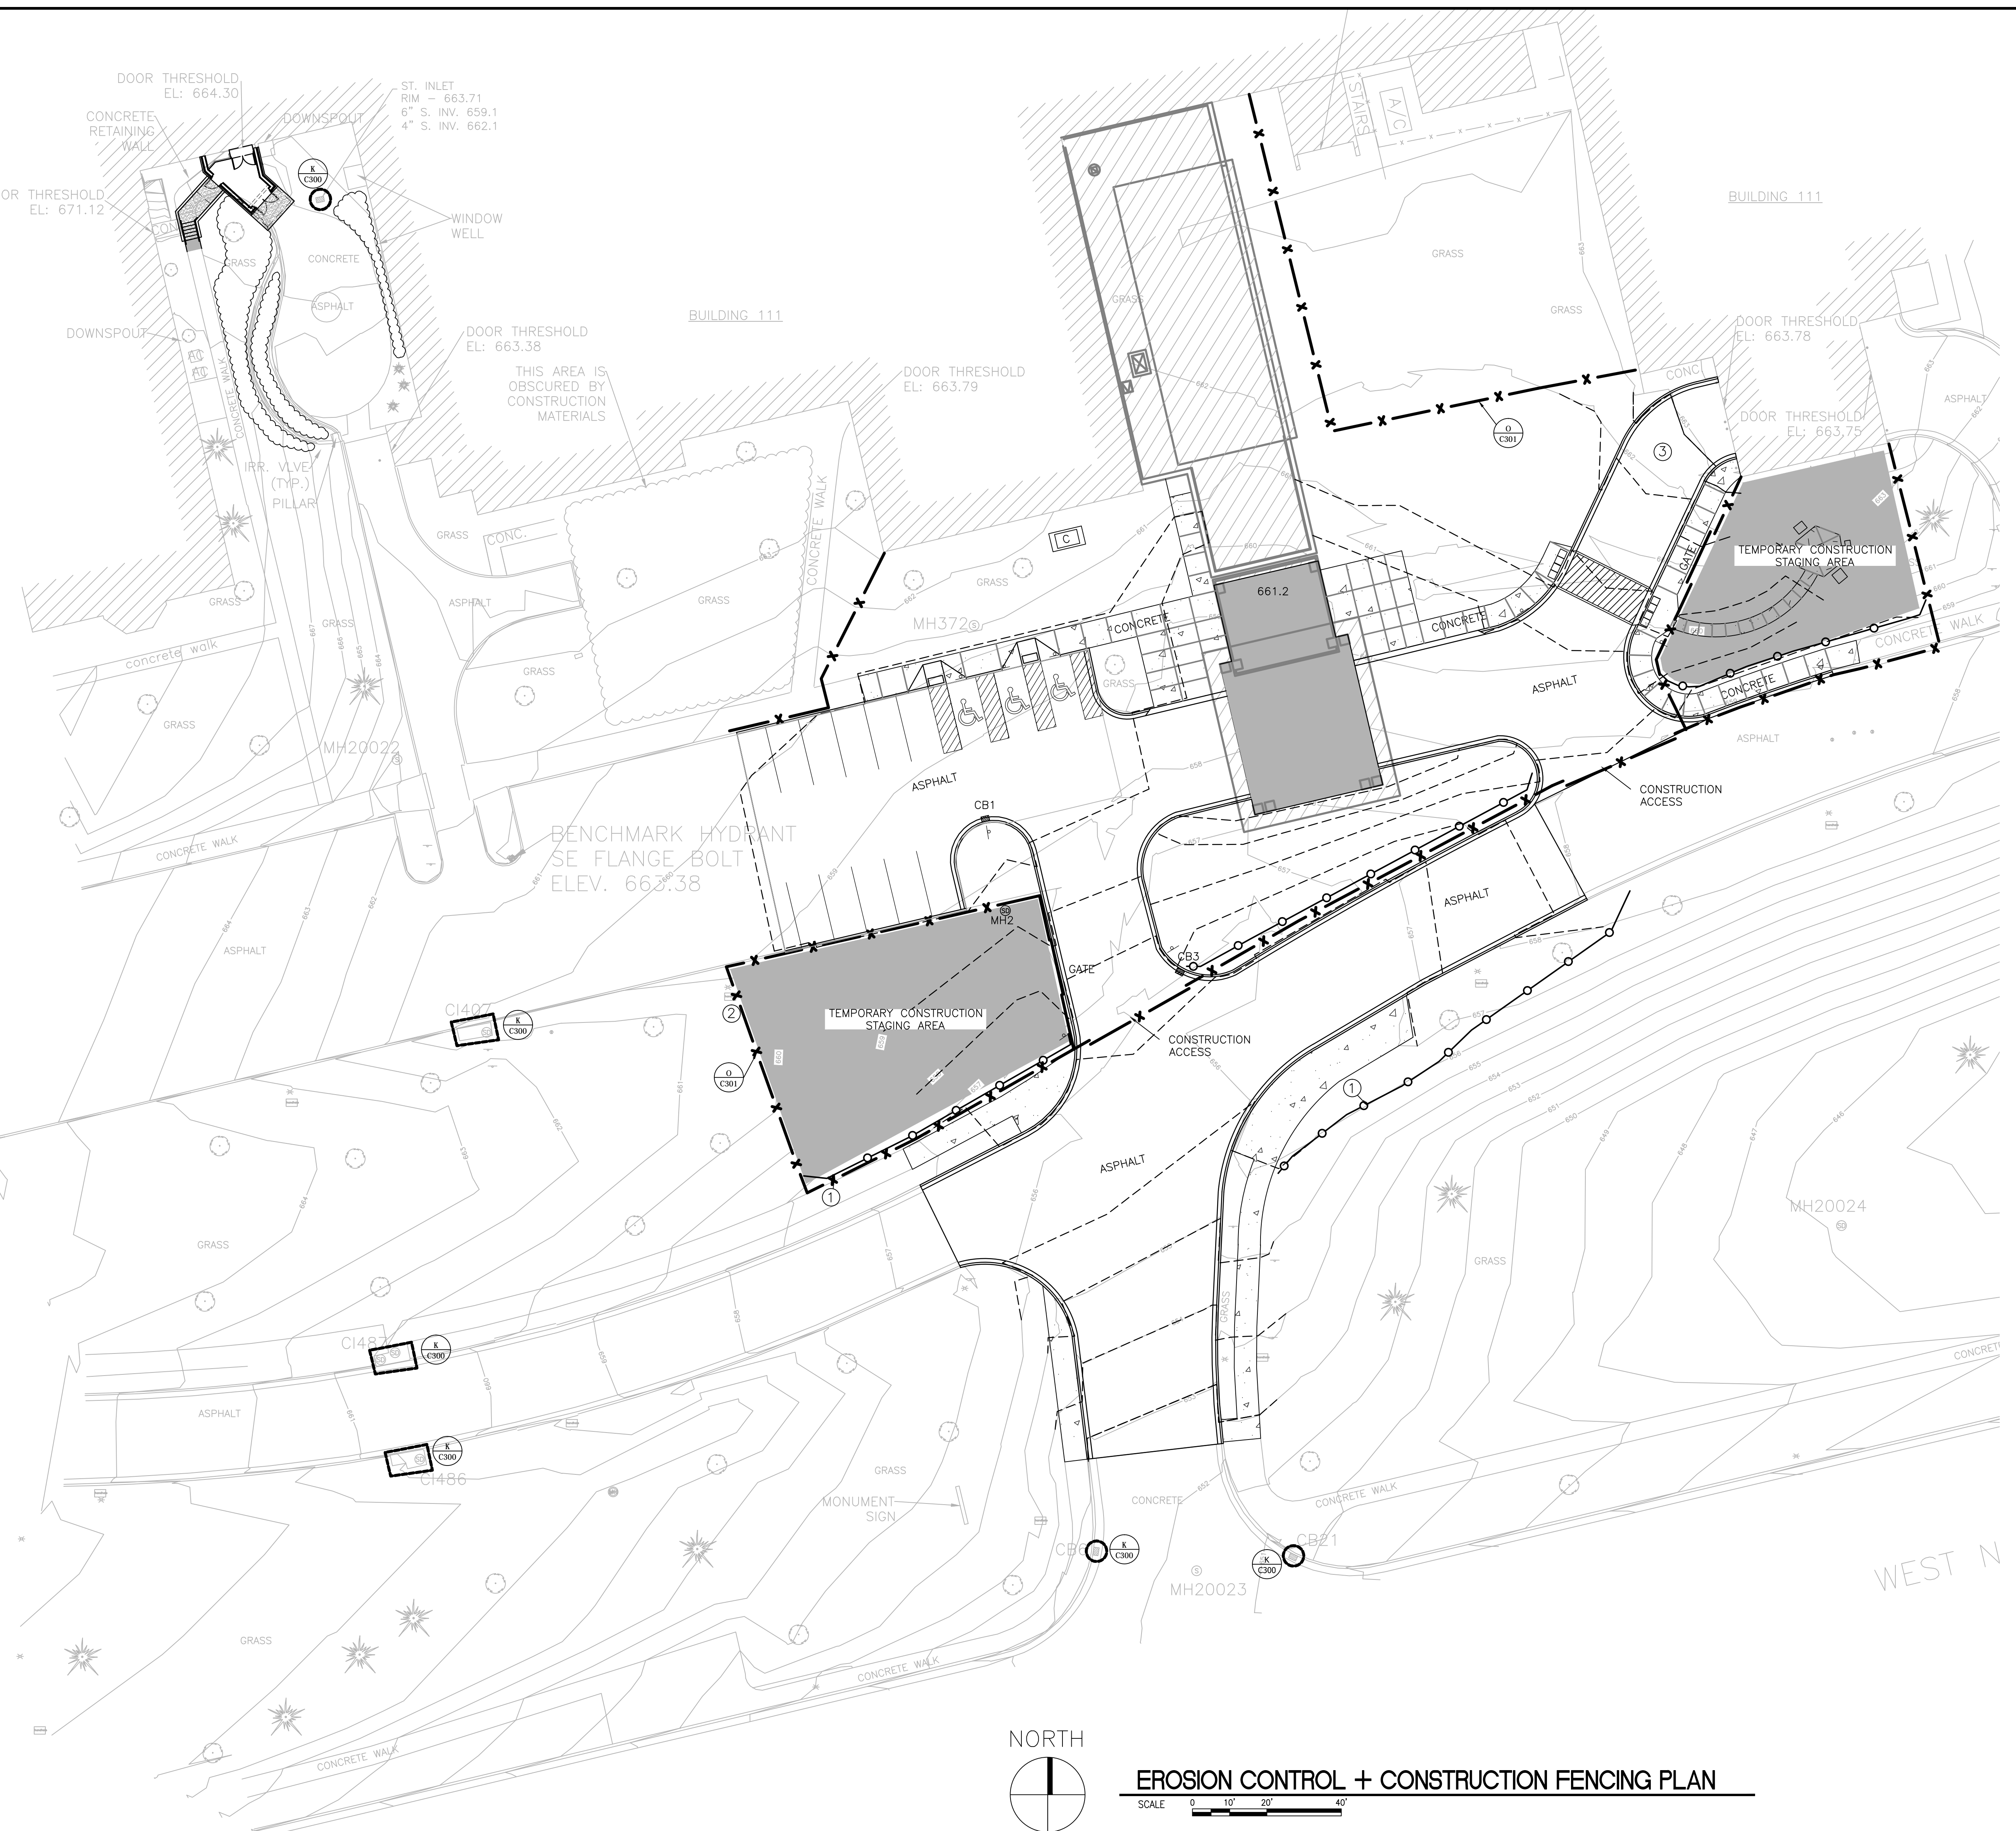






three inches = one foot  
one and one half inches = one foot  
one inch = one foot  
three quarters inch = one foot  
one half inch = one foot  
three eighths inch = one foot  
one quarter inch = one foot  
one eighth inch = one foot

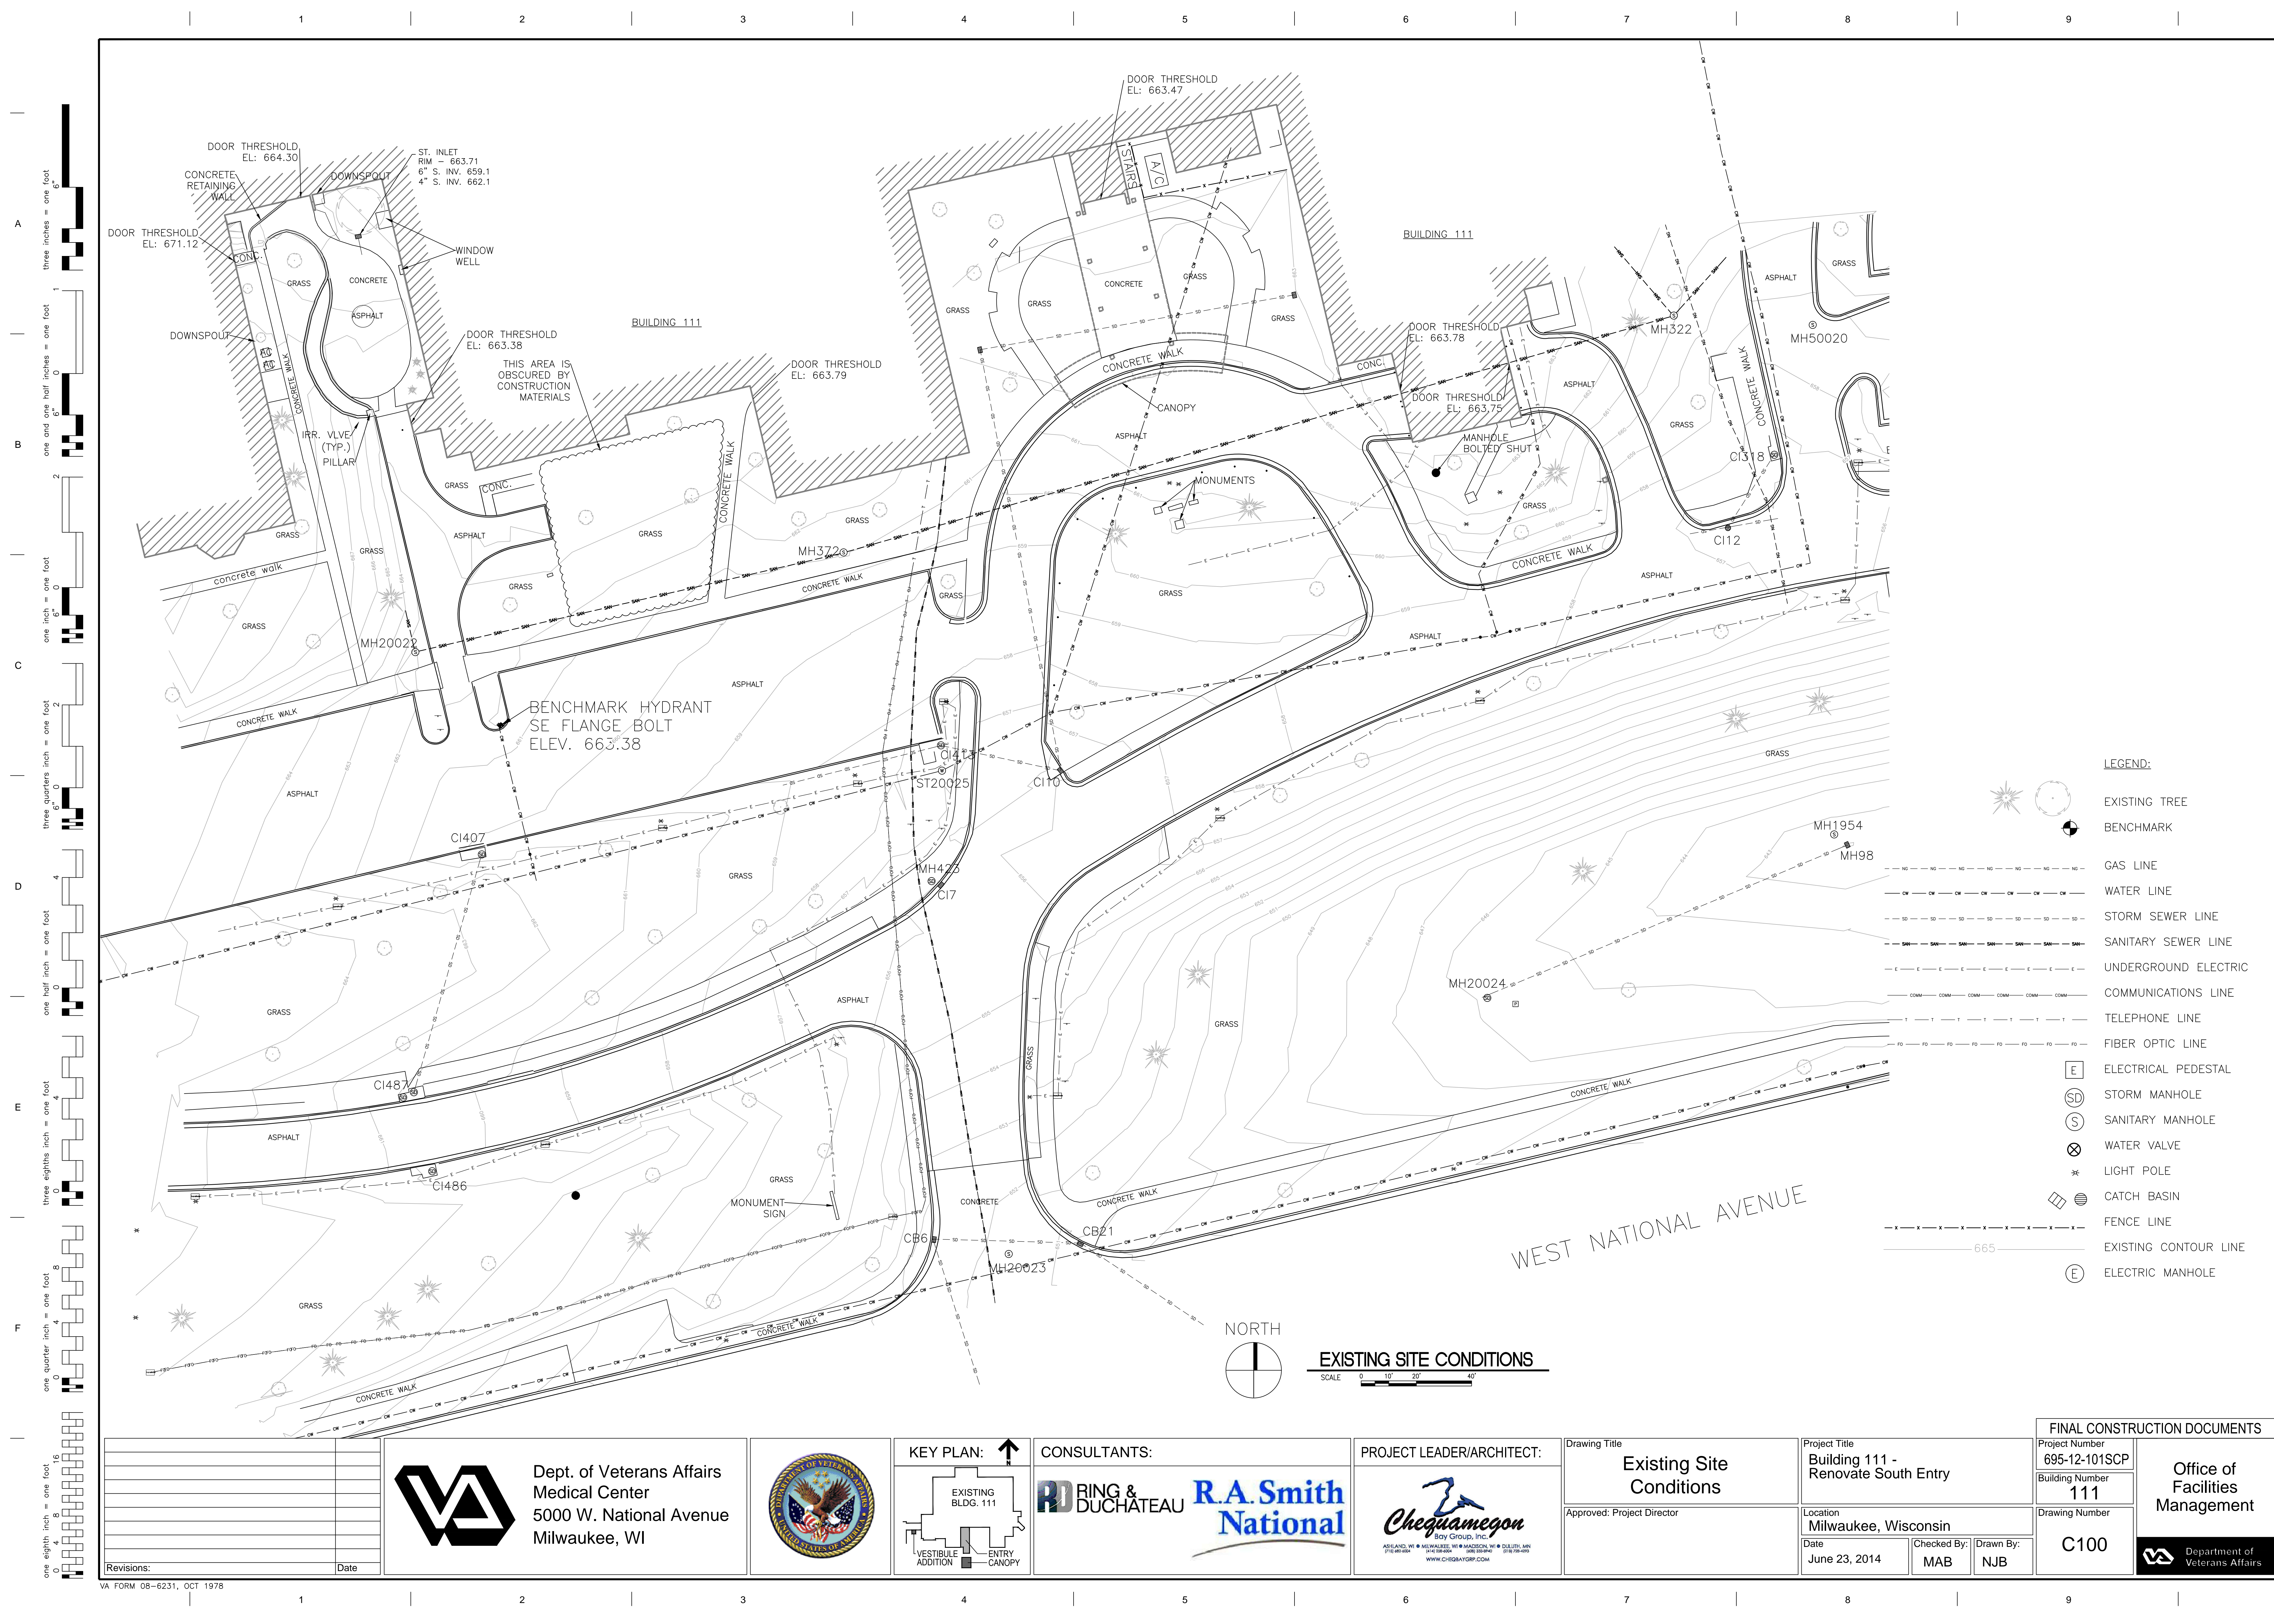- NOTES:
1. TEMPORARY CONTROLS TO BE REMOVED AT PROJECT STABILIZATION
    - SILT FENCE/STRAW BALES
    - TEMPORARY INLET PROTECTION
    - RIPRAP TRACKING PAD
  2. RIPRAP AT OUTFALLS TO BE PERMANENT AS WELL AS EROSION MATTING, SEEDING AND VEGETATIVE METHOD'S SHOWN.
  3. SEED MIXES TO BE REFERENCED FROM LANDSCAPE PLAN.
  4. CONTRACTOR SHALL EMPLOY EROSION CONTROL METHODS AS SHOWN AND SPECIFIED IN WISCONSIN DEPARTMENT OF NATURAL RESOURCES CONSTRUCTION SITE TECHNICAL STANDARDS AND WISDOT EROSION CONTROL PRODUCT ACCEPTABILITY LISTS (PAL).
  5. EROSION CONTROL MEASURES SHALL BE ADJUSTED TO MEET FIELD CONDITIONS AT TIME OF CONSTRUCTION AND SHALL BE INSTALLED PRIOR TO ANY GRADING OR DISTURBANCE OF EXISTING SURFACE MATERIAL ON SITE.
  6. EROSION AND SEDIMENT CONTROL MEASURES SHALL BE CHECKED FOR STABILITY AND OPERATION AFTER A RAINFALL OF 0.5 INCHES OR MORE BUT NO LESS THAN ONCE EVERY WEEK. ANY NEEDED REPAIRS WILL BE MADE IMMEDIATELY. WRITTEN REPORTS, EROSION AND SEDIMENT CONTROL INSPECTIONS ARE AS REQUIRED BY WISCONSIN DEPARTMENT OF NATURAL RESOURCES (WDNR).
  7. SILT FENCE SHALL BE INSTALLED IN LOCATIONS SHOWN ON CONSTRUCTION PLANS. SILT FENCE SHALL BE INSTALLED PER DETAILS ON SHEET C300. SEDIMENT DEPOSITS: REMOVE FROM BEHIND SILT FENCE WHEN DEPOSITS REACH DEPTH OF 6 INCHES. SILT FENCE: REPAIR OR REPLACE TO MAINTAIN BARRIER.
  8. EROSION CONTROL MEASURES SHALL BE MAINTAINED ON CONTINUING BASIS UNTIL SITE IS PERMANENTLY STABILIZED. SITE STABILIZATION INVOLVING SEEDING WHICH IS NOT COMPLETED PRIOR TO SEPTEMBER 15 SHALL BE COMPLETED WITH DORMANT SEEDING BY NOVEMBER 1. SODDING MAY OCCUR ANYTIME SOD IS AVAILABLE AND SOD AND SOIL IS NOT FROZEN.
  9. INLET GRATE SCREENS SHALL BE INSTALLED ON EXISTING AND PROPOSED INLETS AND CATCH BASINS. REFERENCE SITE UTILITY DRAWINGS FOR LOCATION OF PROPOSED INLETS AND CATCH BASINS. FOR STRUCTURES IN DISTURBED AREAS THAT WILL NOT BE FINISHED AND VEGETATION ESTABLISHED WITHIN 30 DAYS, CURB INLET SEDIMENT BARRIERS SHALL BE USED IN LIEU OF INLET GRATE SCREENS. INLET PROTECTION SHALL BE PER PLAN AND DETAILS.
  10. EROSION CONTROL MEASURES MUST BE IN PLACE AT END OF EACH WORKDAY.
  11. SEDIMENT DEPOSIT/TRACKING FROM CONSTRUCTION WORK OR STORM EVENTS: CLEAN UP BY END OF EACH DAY. FLUSHING NOT ALLOWED.
  12. WHERE CONSTRUCTION ACTIVITIES HAVE PERMANENTLY CEASED OR HAVE TEMPORARILY BEEN SUSPENDED FOR MORE THAN FOURTEEN DAYS, OR WHEN FINAL GRADES ARE REACHED IN ANY PORTION OF SITE, STABILIZATION SHALL BE IMPLEMENTED WITHIN SEVEN DAYS. TEMPORARY STABILIZATION PRACTICES SUCH AS MULCH/TACKIFIER, EROSION MAT, OR WISDOT TYPE B SOIL STABILIZER (POLYMER) SHALL BE APPLIED TO SOIL SURFACE WHEN SITE IS NOT READY FOR PERMANENT RESTORATION. WHEN STABILIZATION NOT POSSIBLE DUE TO SNOW COVER, STABILIZATION MEASURES SHALL BE INITIATED AS SOON AS POSSIBLE.
  13. DUST CONTROL SHALL BE IMPLEMENTED THROUGHOUT CONSTRUCTION AND SHALL UTILIZE METHODS OUTLINED IN WDNR TECH STD. 106B. AT MINIMUM, WATER SPRAY OPEN SOIL AND TRACKING ONCE EACH WORK DAY.
  14. REMOVAL OF VEGETATIVE COVER AND EXPOSURE OF BARE GROUND MUST BE RESTRICTED TO MINIMUM AMOUNT NECESSARY FOR CONSTRUCTION. AREAS WHERE SOIL IS EXPOSED MUST BE PROTECTED FROM EROSION BY SEEDING AND MULCHING, SODDING, DIVERSION OF SURFACE RUNOFF, INSTALLATION OF STRAW BALES OR SILT SCREENS, CONSTRUCTION OF SETTLING BASINS, OR SIMILAR METHODS AS SOON AS POSSIBLE AFTER REMOVAL OF ORIGINAL GROUND COVER AS DESCRIBED IN WISCONSIN DNR TECHNICAL STANDARDS. ANY STOCKPILE THAT REMAINS OVER 7 DAYS MUST BE STABILIZED WITH MIXTURE NO. 20 FROM WISDOT SECTION 630.
  15. STORM WATER AND GROUND WATER PUMPED FROM EXCAVATIONS AND/OR DEWATERING WELLS SHALL BE DISPOSED OF IN ACCORDANCE WITH WISCONSIN STATUTES. SEDIMENT BASINS, SEDIMENT TRAPS AND/OR USE OF POLYMERS TO CONTROL SEDIMENT: NOT ALLOWED. DISCHARGE OR PUMPED WATER TO SANITARY SEWERS: NOT ALLOWED.
  16. EROSION MAT SHALL CONSIST ENTIRELY OF BIODEGRADABLE COMPONENTS. EVERY SQUARE INCH SHALL BE SECURED TO GROUND: NO BUCKLING, NO GAPS.
  17. AFTER SITE IS UNIFORMLY STABILIZED ACROSS 80% OF SITE AREA, OR PRIOR TO, AT DIRECTION OF DEPARTMENT OF NATURAL RESOURCES, REMOVE TEMPORARY EROSION CONTROL MEASURES AND DISPOSE OF PROPERLY. ANY REMAINING TEMPORARY EROSION CONTROL DEVICES AFTER THIS POINT CONSTITUTE LITTERING AND MAY BE ENFORCED AS DETERMINED NECESSARY BY DEPARTMENT OF NATURAL RESOURCES.
  18. CONTRACTOR SHALL MAINTAIN LOG OF EROSION CONTROL INSPECTIONS, REPAIRS MADE, AND RAIN EVENTS. SUBMIT WITH PAY REQUESTS.
  19. PLACE MINIMUM OF 6 INCHES OF TOPSOIL IN AREAS TO RECEIVE PERMANENT SEEDING, MULL, GRIND, AND SCREEN SOD AND TOPSOIL REUSED FROM SITE CLEARING AND GRUBBING. OFF-SITE TOPSOIL: TEST (PHYSICAL AND CHEMICAL) AND PROVE MEETS SPECIFICATIONS, PER EACH SOURCE, AND SUBMIT SAMPLES BEFORE DELIVERY, NUMBER AND TYPE SPECIFIED.
  20. ALL CATCH BASINS DOWNSTREAM/DOWNGRADIENT OR NEAR CONSTRUCTION ACTIVITIES WILL BE REQUIRED TO BE FITTED WITH WISDOT TYPE B, C, OR D INLET PROTECTION
  21. CONSTRUCTION FENCING LOCATIONS ARE APPROXIMATE. GENERAL CONTRACTOR TO COORDINATE TEMPORARY FENCING WITH APPROVED CONSTRUCTION PHASING PLAN.
  22. CONTRACTOR TO REMOVE TREES, SHRUBS, TOPSOIL AS WELL AS EXCAVATED MATERIAL, AS A RESULT OF BUILDING ADDITION EXCAVATIONS, UTILITY TRENCHES, ETC. FROM THE JOB SITE DAILY. NO MATERIAL IS TO BE STORED ON UNIVERSITY PROPERTY DURING CONSTRUCTION.
  23. GENERAL CONTRACTOR TO COORDINATE PEDESTRIAN TRAVEL INTO UPDATED PHASING PLAN PRIOR TO CONSTRUCTION ACTIVITIES AT ANY OF THE NEW CONSTRUCTION LOCATIONS. SAFE PEDESTRIAN TRAVEL MUST BE MAINTAINED AT ALL TIMES.
  24. WHERE CONTRACTOR WILL BE TRACKING DIRT AND DEBRIS ONTO PUBLIC STREETS AS A RESULT OF CONSTRUCTION ACTIVITIES, GENERAL CONTRACTOR IS TO INSTALL TRACKING PADS AS TO MINIMIZE TRACKING SOIL AND DEBRIS INTO STREETS.
  25. CONTRACTOR SHALL PRACTICE GOOD HOUSEKEEPING AND MAY BE REQUIRED TO INCLUDE DAILY STREET SWEEPING ACTIVITIES AS DIRECTED BY THE UNIVERSITY STAFF.



- KEY NOTES:
1. 250 L.F. OF SILT FENCE INSTALLED PER WISDOT/WDNR STANDARDS.
  2. GENERAL CONTRACTOR TO ESTABLISH STAGING AREA. GENERAL CONTRACTOR TO INSTALL 7' TALL CHAIN LINK CONSTRUCTION FENCE AROUND STAGING AREA WITH LOCKS. ANY DAMAGE TO EXISTING FEATURES IS TO BE REPAIRED OR REPLACED AT NO COST TO VAMC.
  3. GENERAL CONTRACTOR TO COORDINATE WITH VAMC PROJECT MANAGER. AMBULANCE BAY TO REMAIN OPERATIONAL AT ALL TIMES. NEW ROAD CONSTRUCTION TO MAINTAIN A SINGLE LANE OF TRAFFIC TO ALLOW AMBULANCE USE AT ALL TIMES.

NOTE:  
6 INLETS REQUIRE TYPE C OR D INLET PROTECTION.

LEGEND:

- EXISTING TREE
- BENCHMARK
- ELECTRICAL PEDESTAL
- STORM MANHOLE
- SANITARY MANHOLE
- WATER VALVE
- LIGHT POLE
- CATCH BASIN
- FENCE LINE
- ELECTRIC MANHOLE
- SILT FENCE
- INLET PROTECTION
- CONSTRUCTION FENCE


NORTH

EROSION CONTROL + CONSTRUCTION FENCING PLAN

SCALE 0 10' 20' 40'

 Dept. of Veterans Affairs Medical Center 5000 W. National Avenue Milwaukee, WI		KEY PLAN: ↑ EXISTING BLDG. 111 VESTIBULE ADDITION ENTRY CANOPY	CONSULTANTS:  	PROJECT LEADER/ARCHITECT: 	Drawing Title <b>Erosion Control &amp; Construction Fencing Plan</b>		Project Title <b>Building 111 - Renovate South Entry</b>		FINAL CONSTRUCTION DOCUMENTS	
					Approved: Project Director		Location <b>Milwaukee, Wisconsin</b>		Project Number <b>695-12-101SCP</b>	
					Date June 23, 2014		Checked By: MAB		Building Number <b>111</b>	
					Drawn By: NJB		Drawing Number <b>C101</b>			




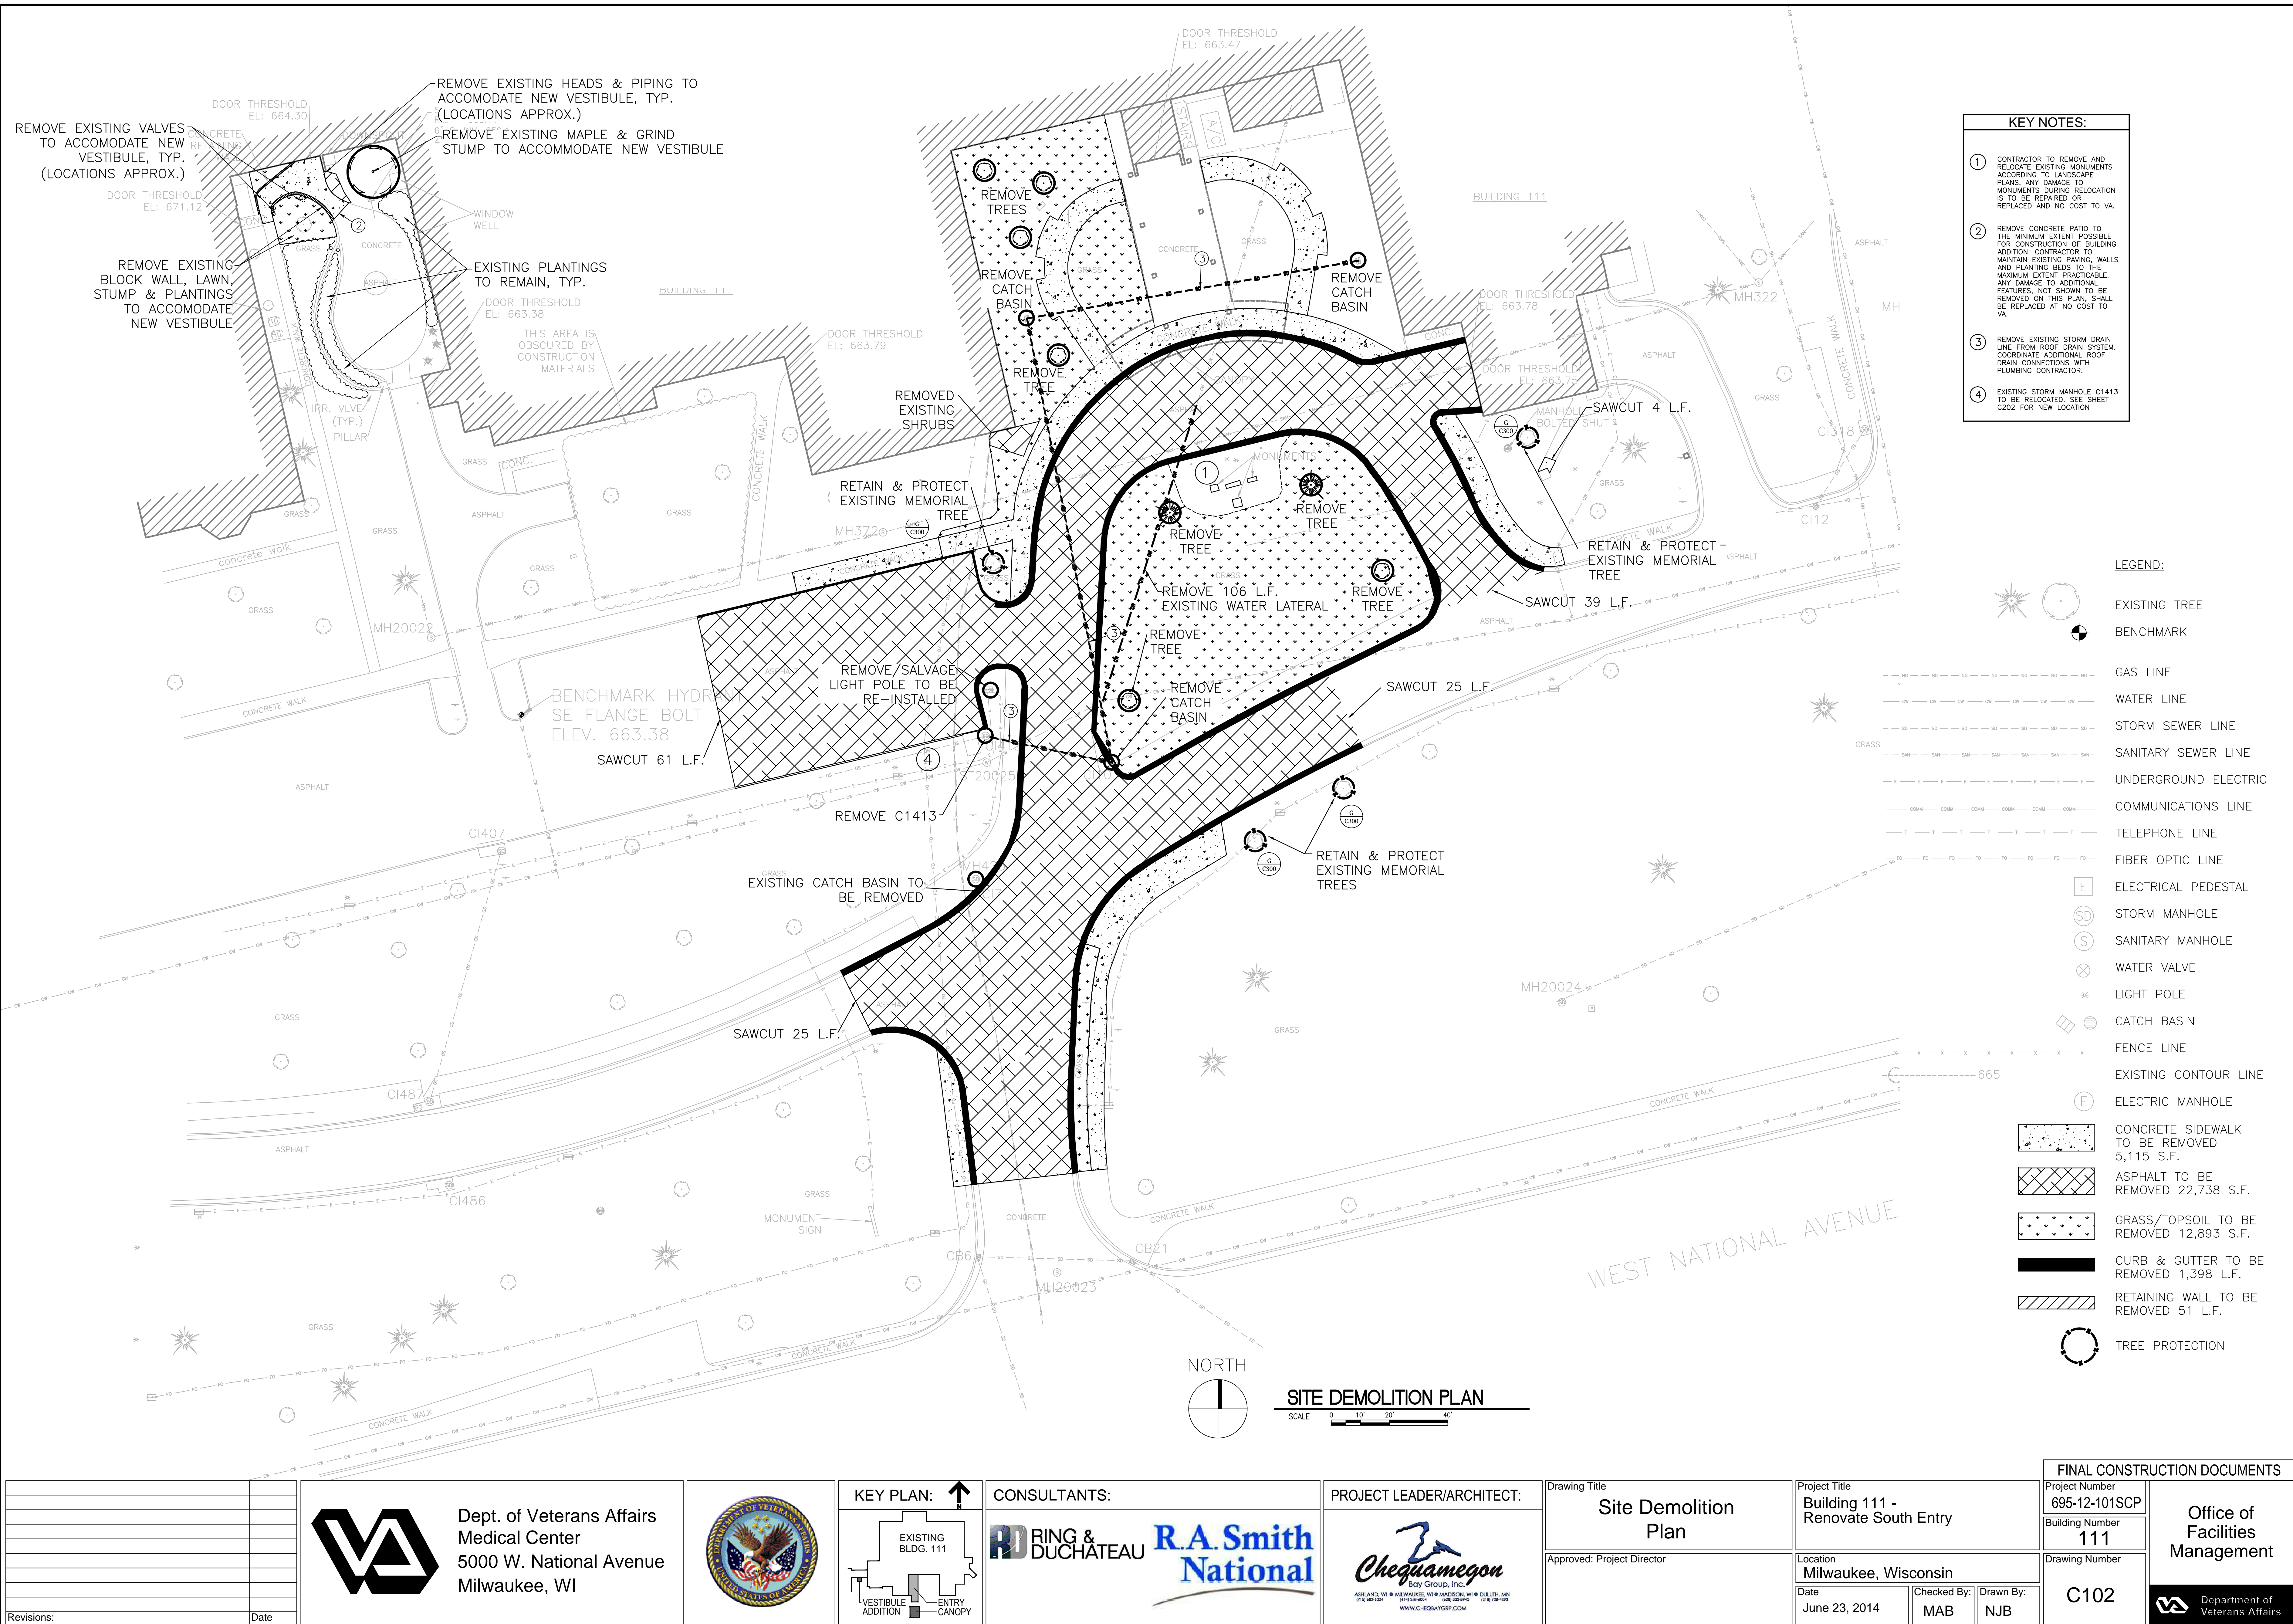








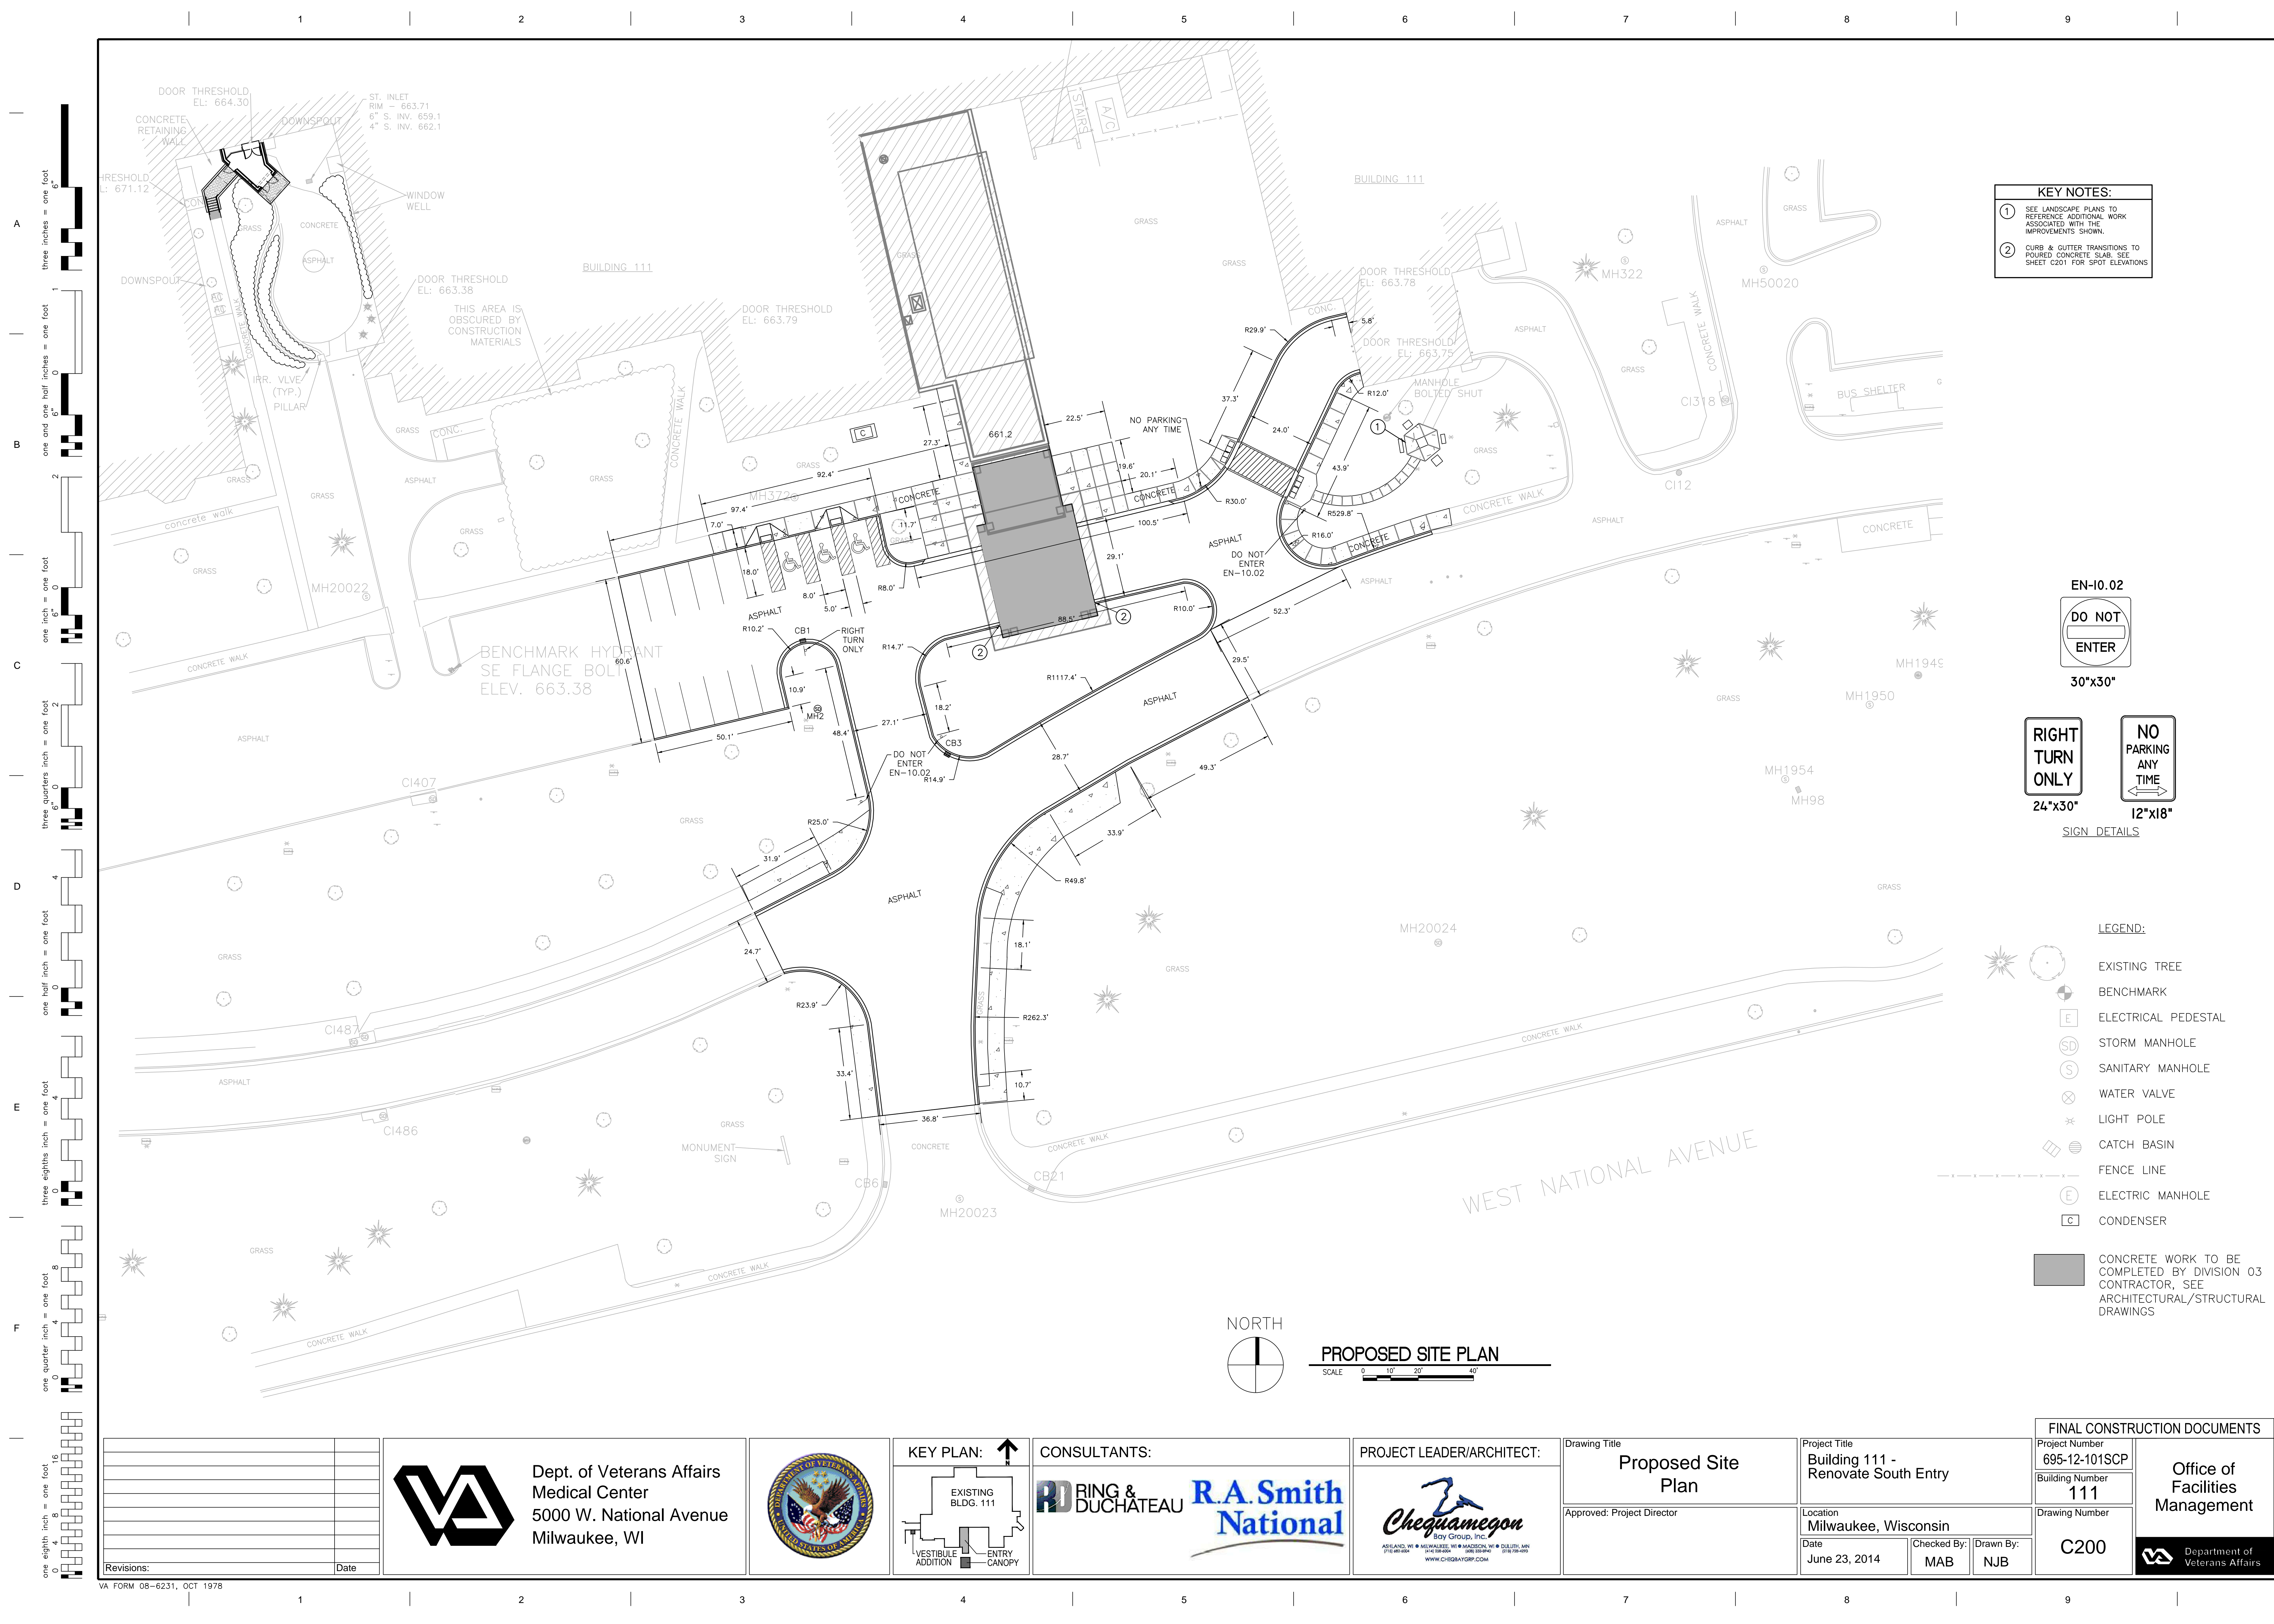







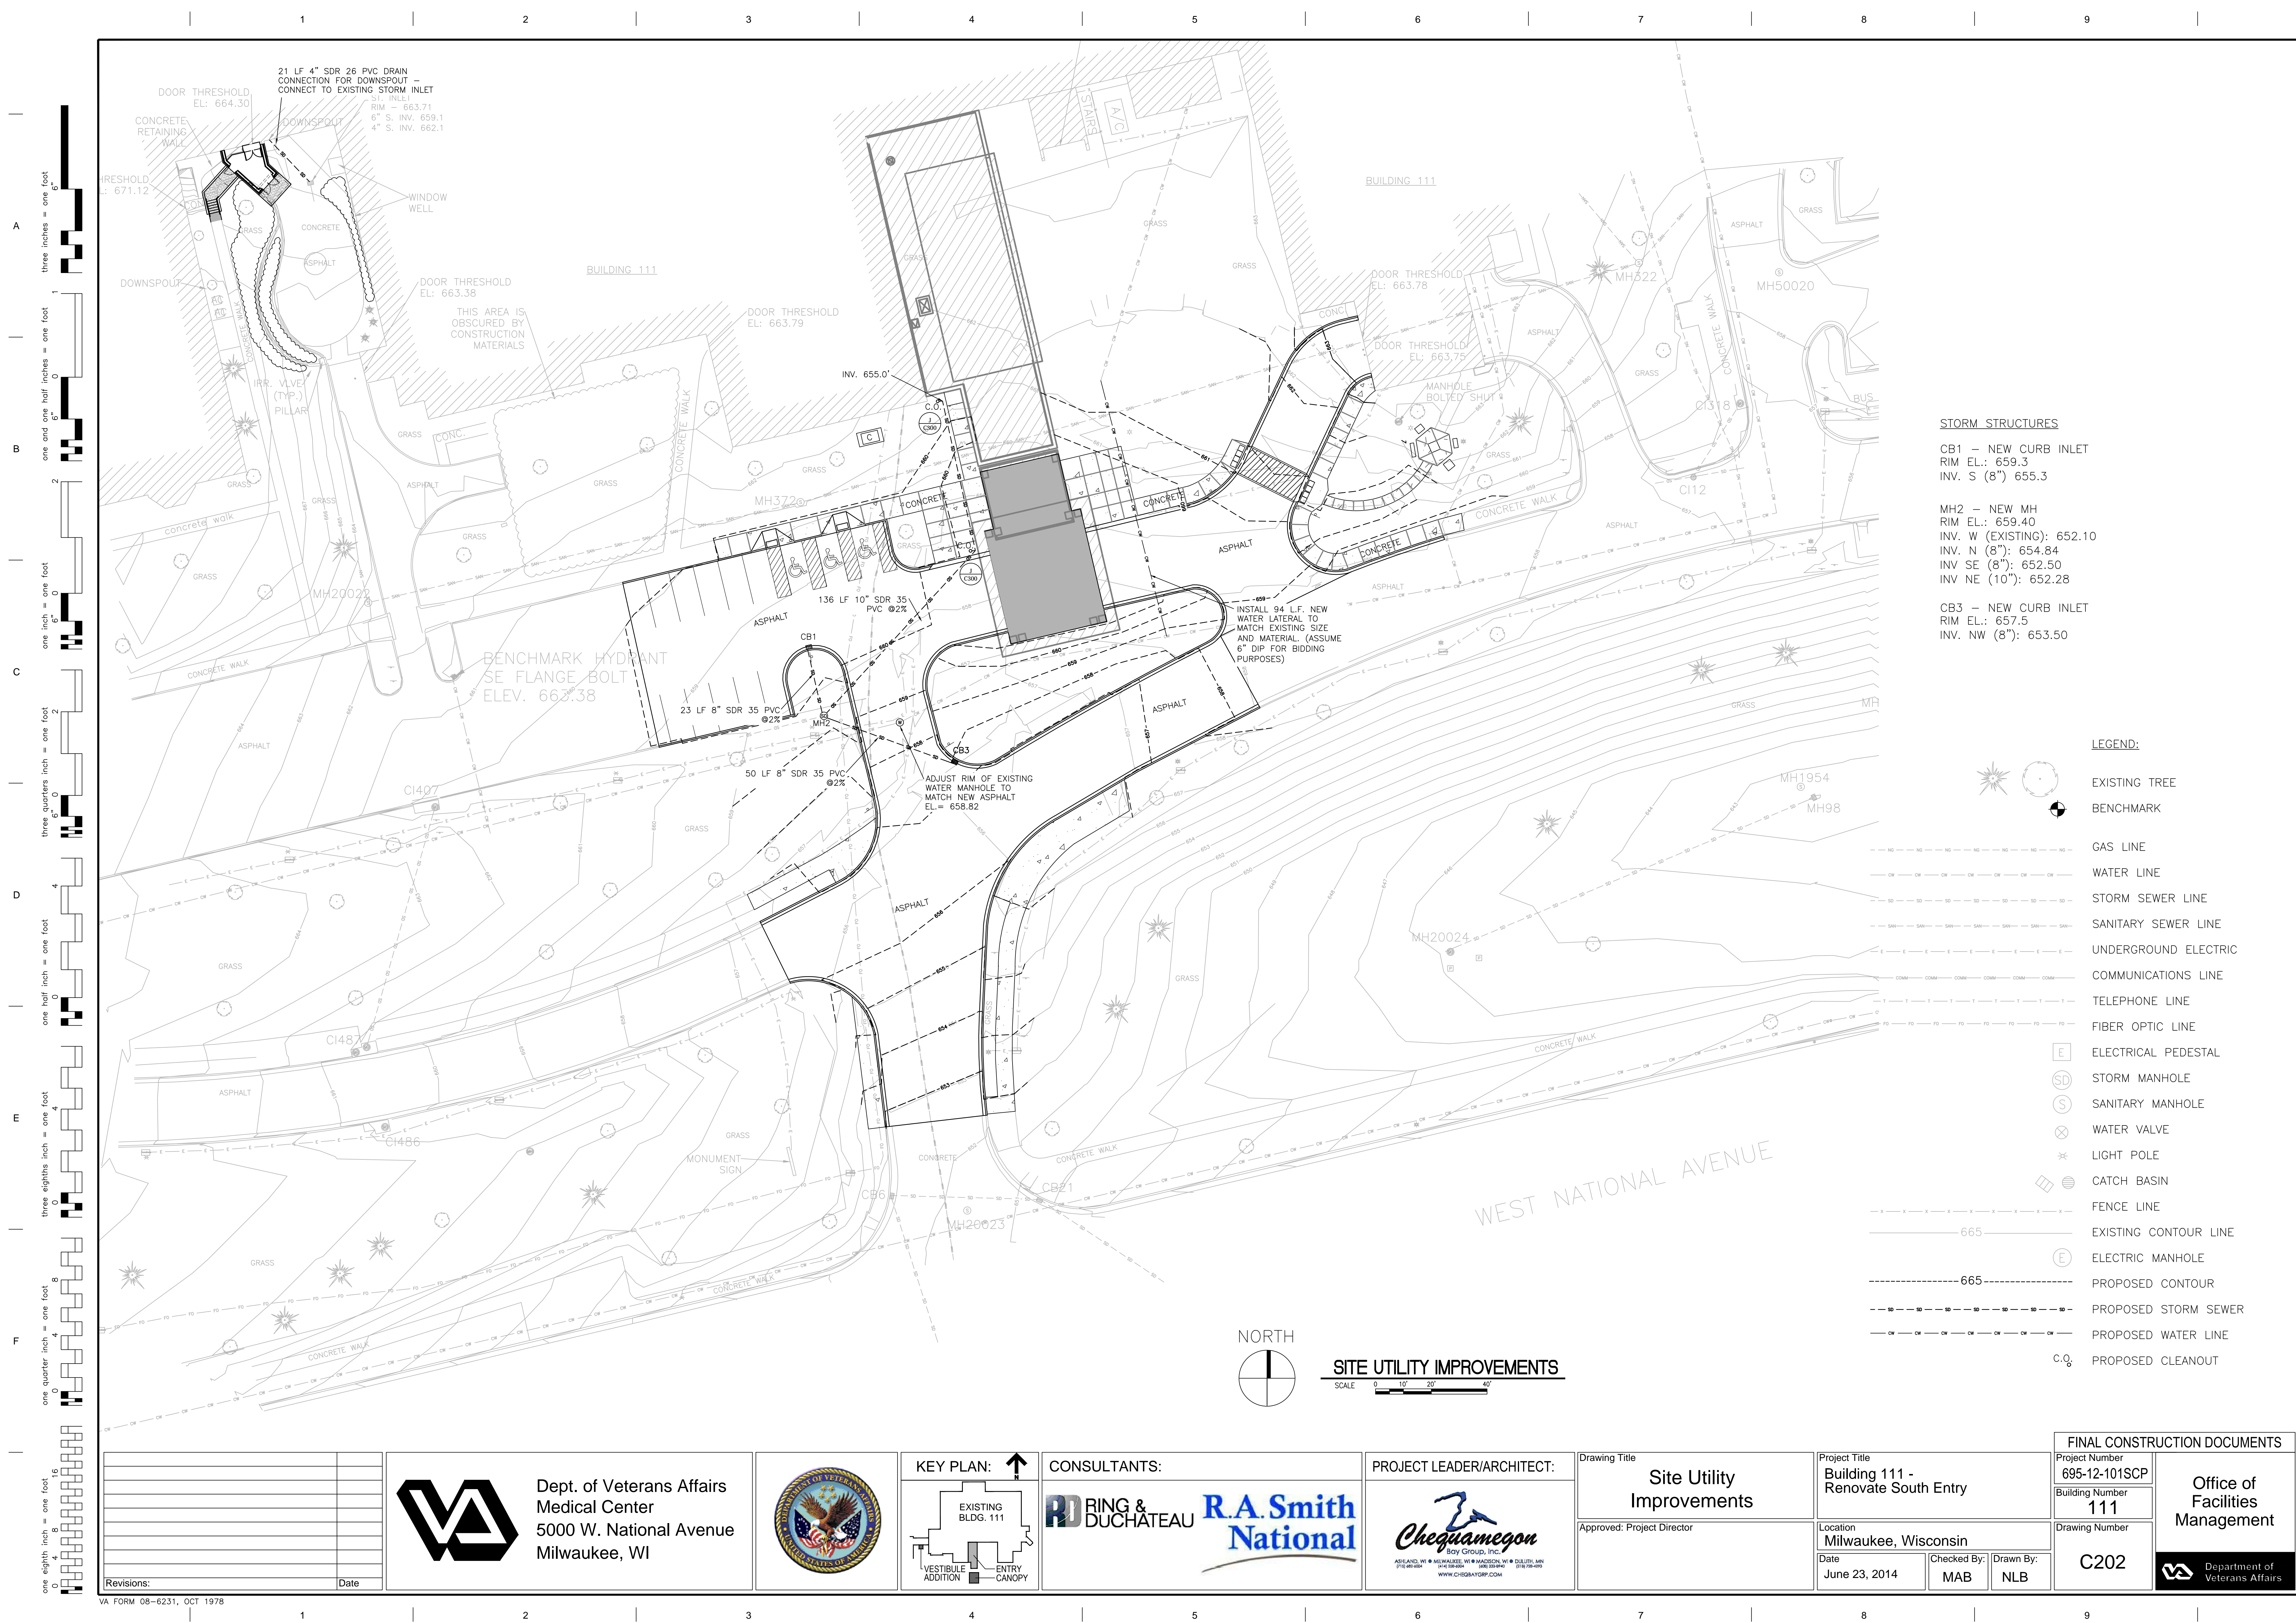













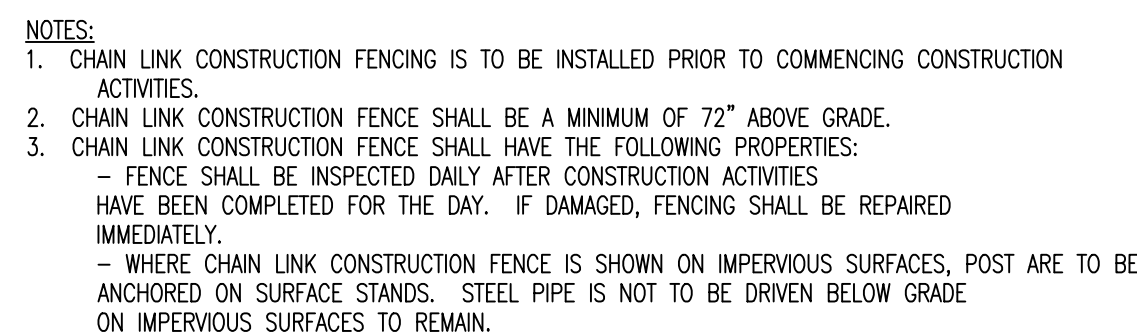

Dept. of Veterans Affairs  
Medical Center  
5000 W. National Avenue  
Milwaukee, WI

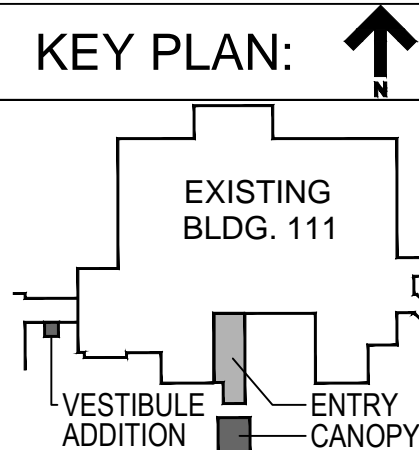

CONSULTANTS:




PROJECT LEADER/ARCHITECT:



	Drawing Title
--	---------------

## Civil Details

Approved: Project Director

Project Title
---------------

Building 111 -  
Renovate South Entry

Location	Milwaukee, Wisconsin
----------	----------------------

Checked By	MAB
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Drawn By  
NJB

FINAL CONSTRUCTION DOCUMENTS

Project Number	
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Building Number

Drawing Number

C301

Office of  
Facilities  
Management
























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**DECIDUOUS TREE PLANTING DETAIL**




NOT TO SCALE

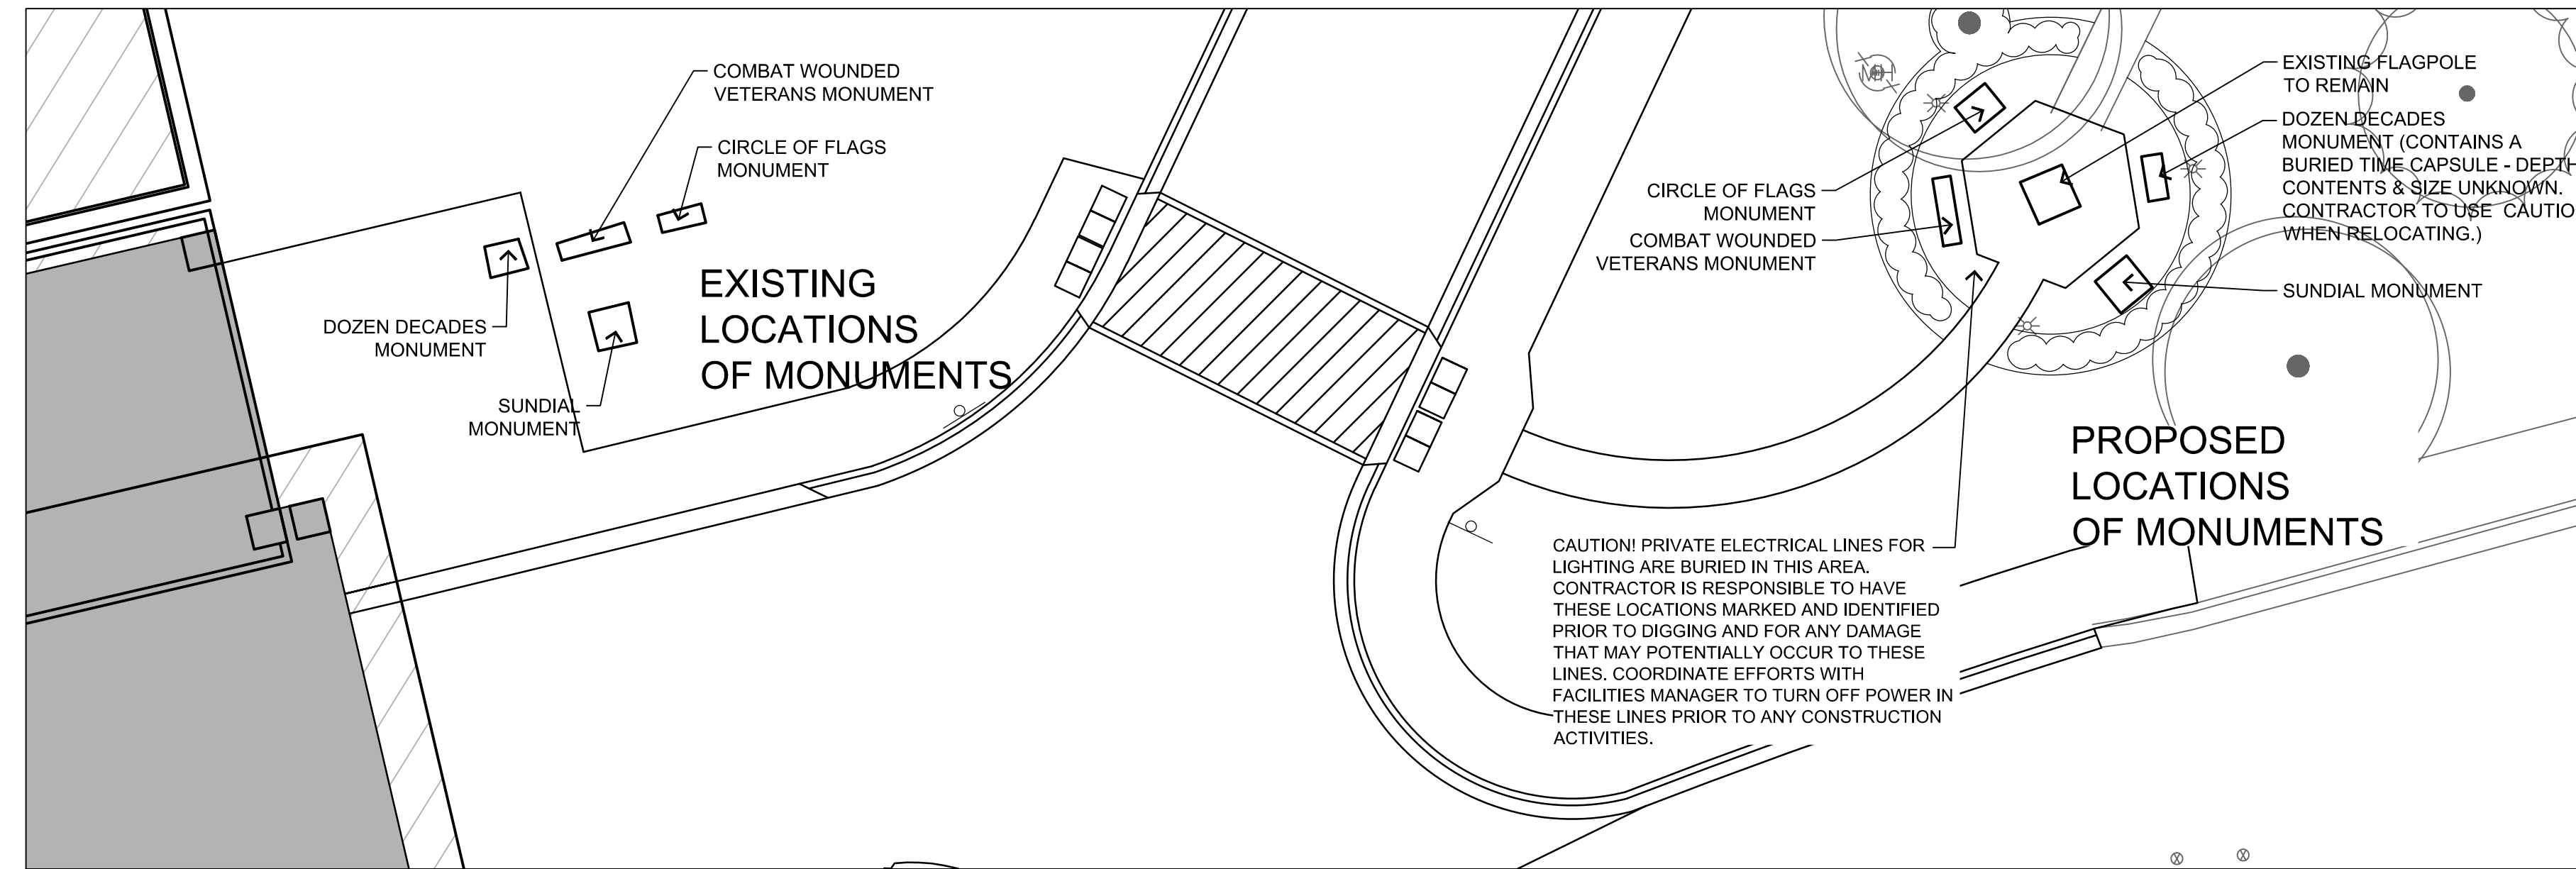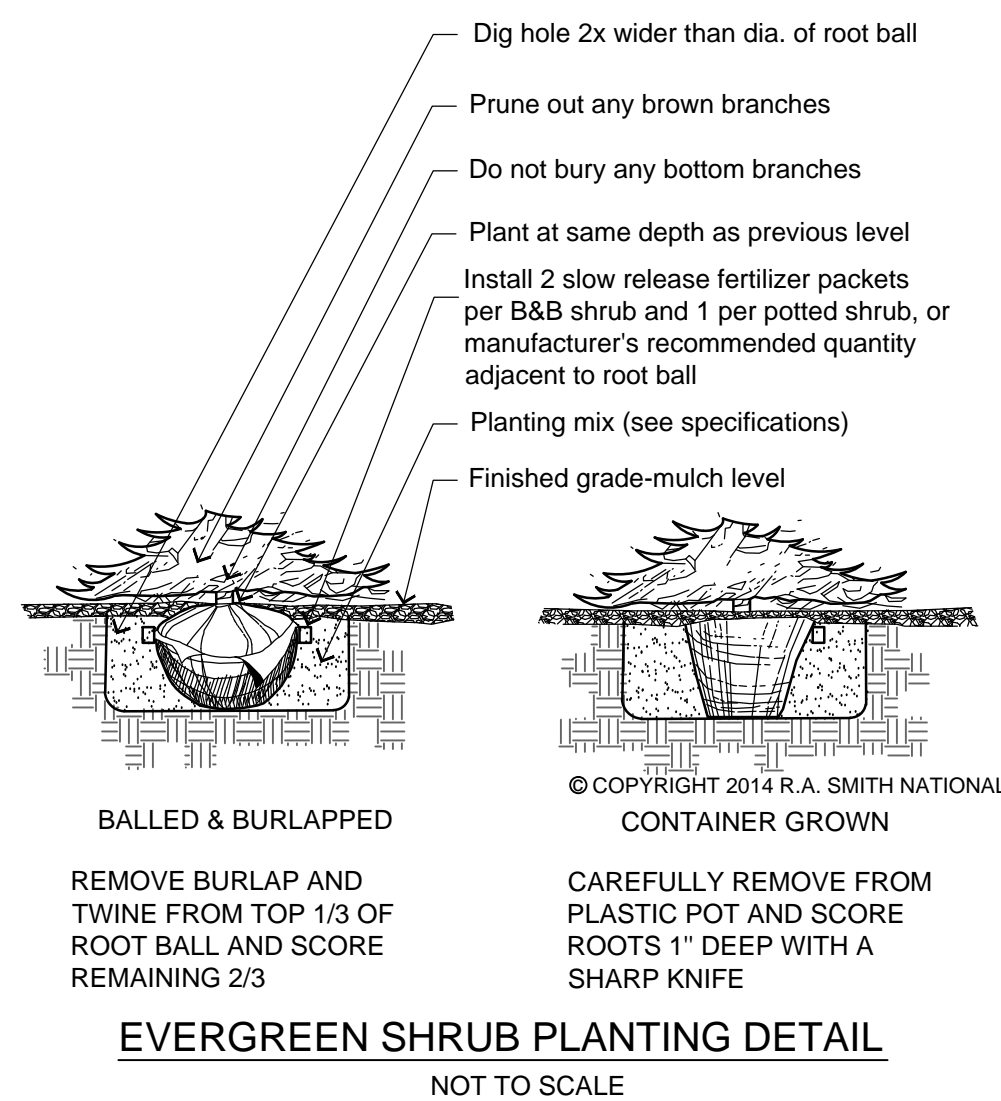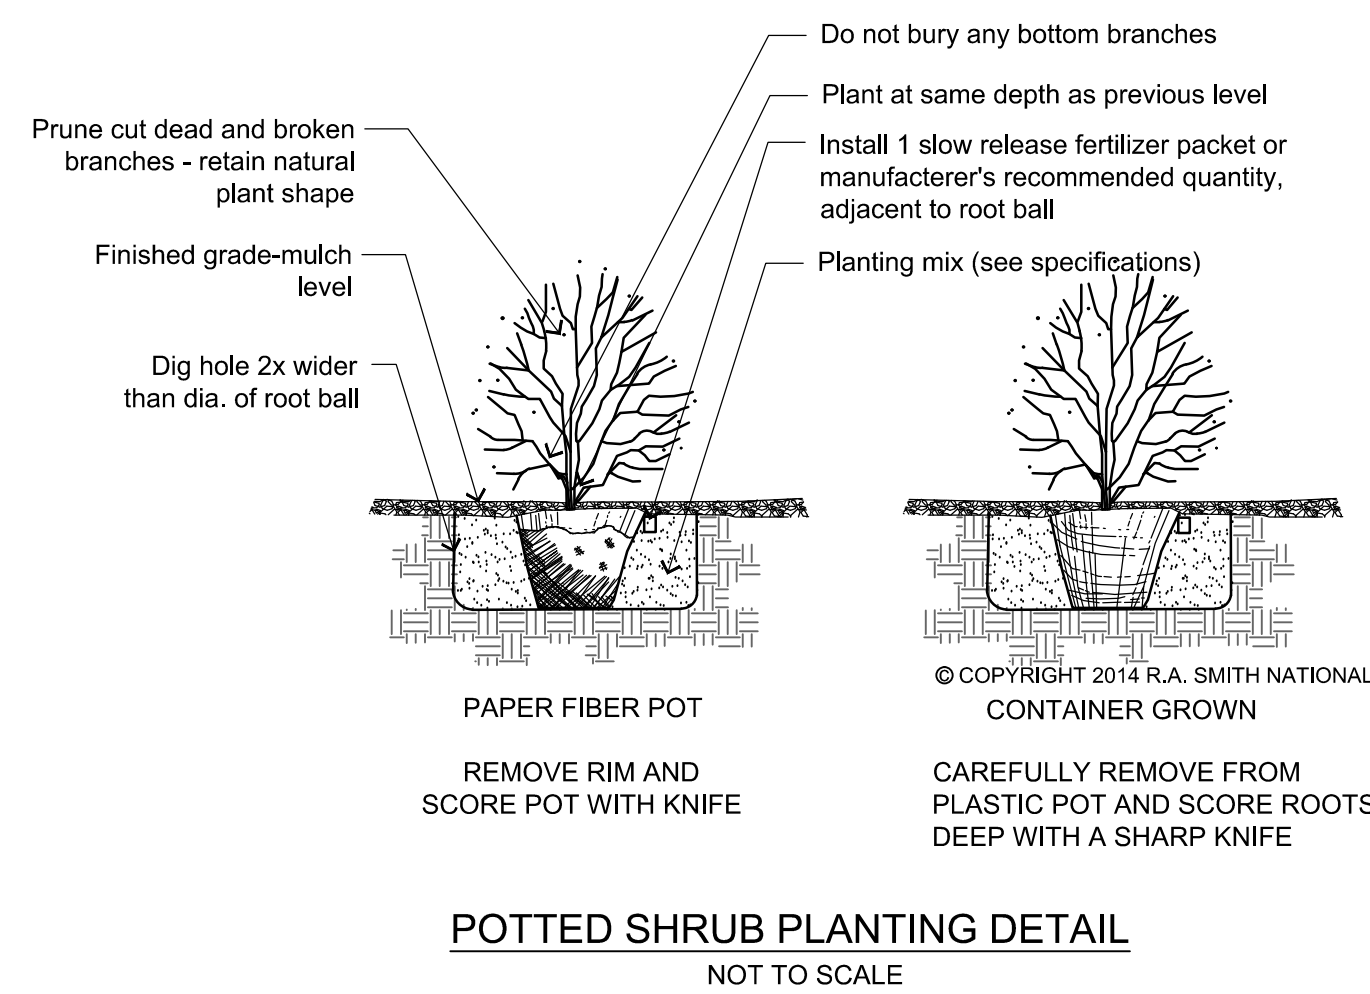

SCALE: 1" = 10'

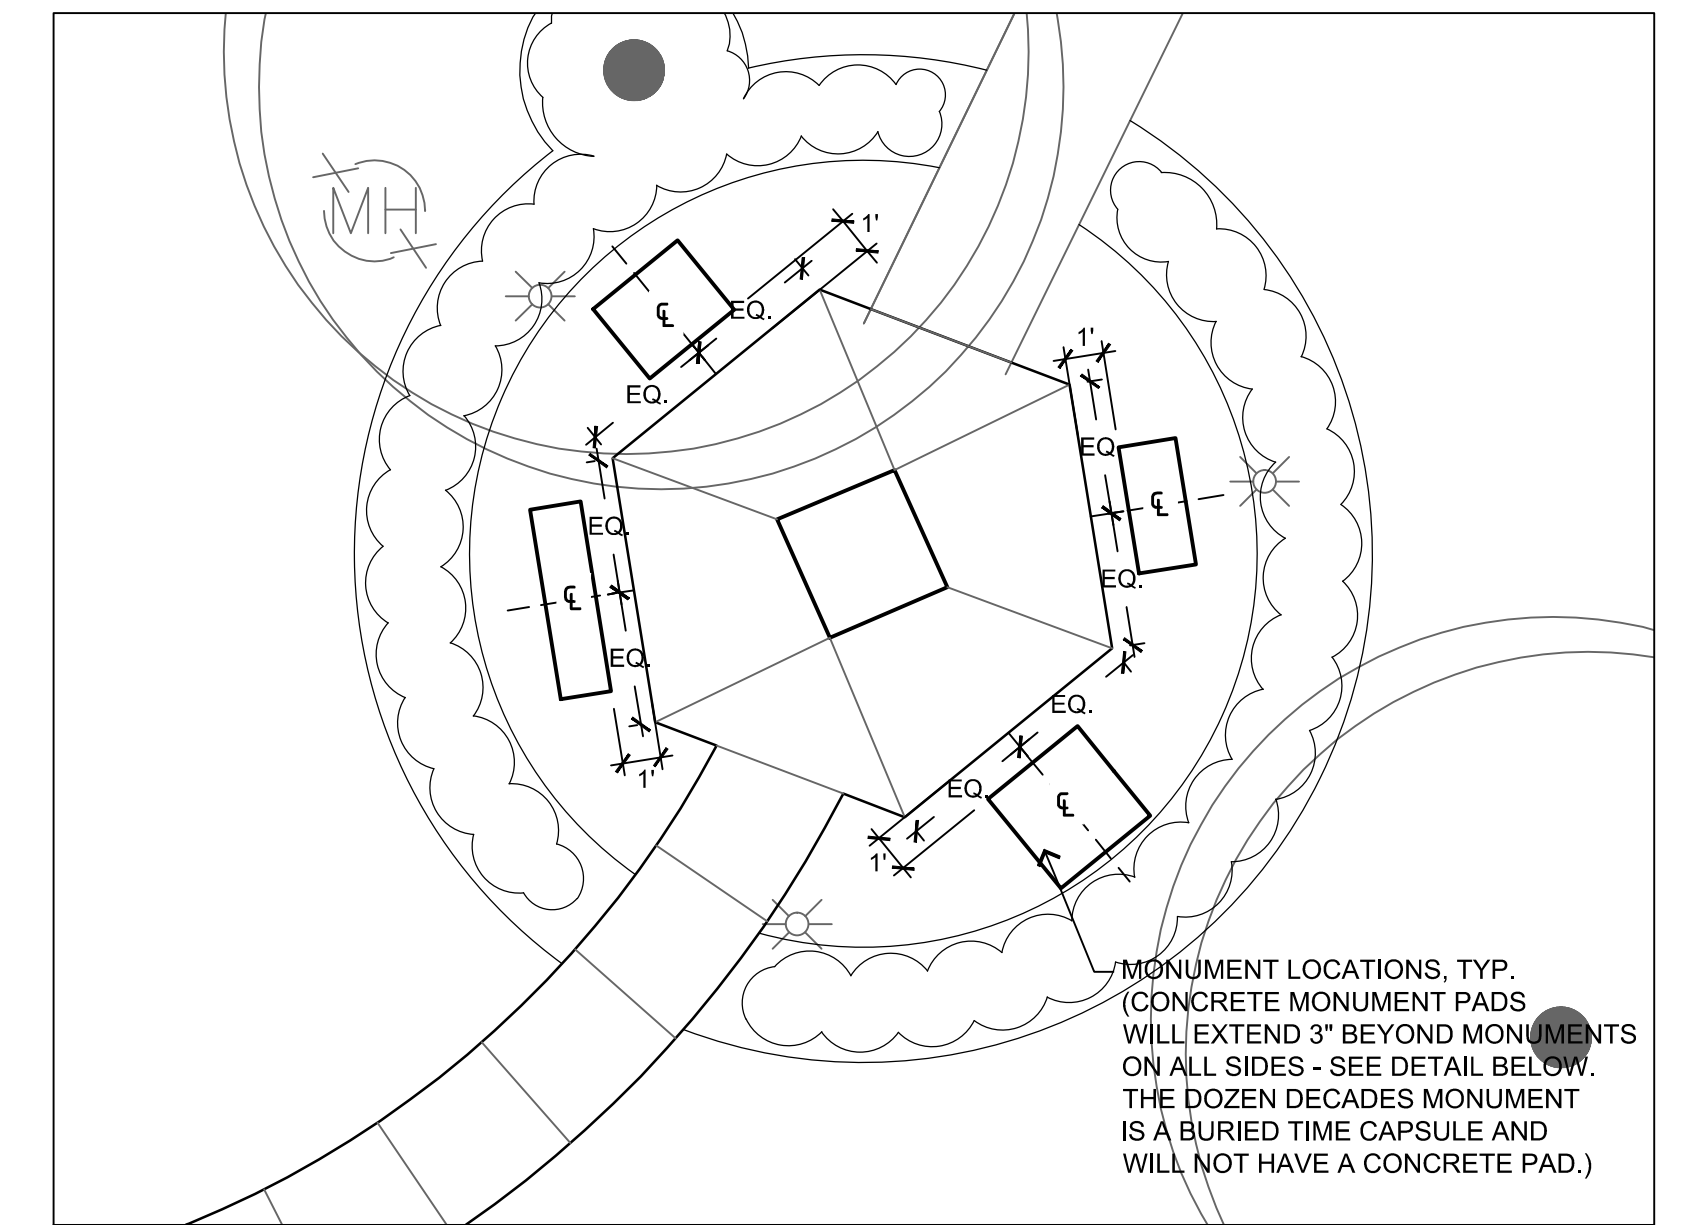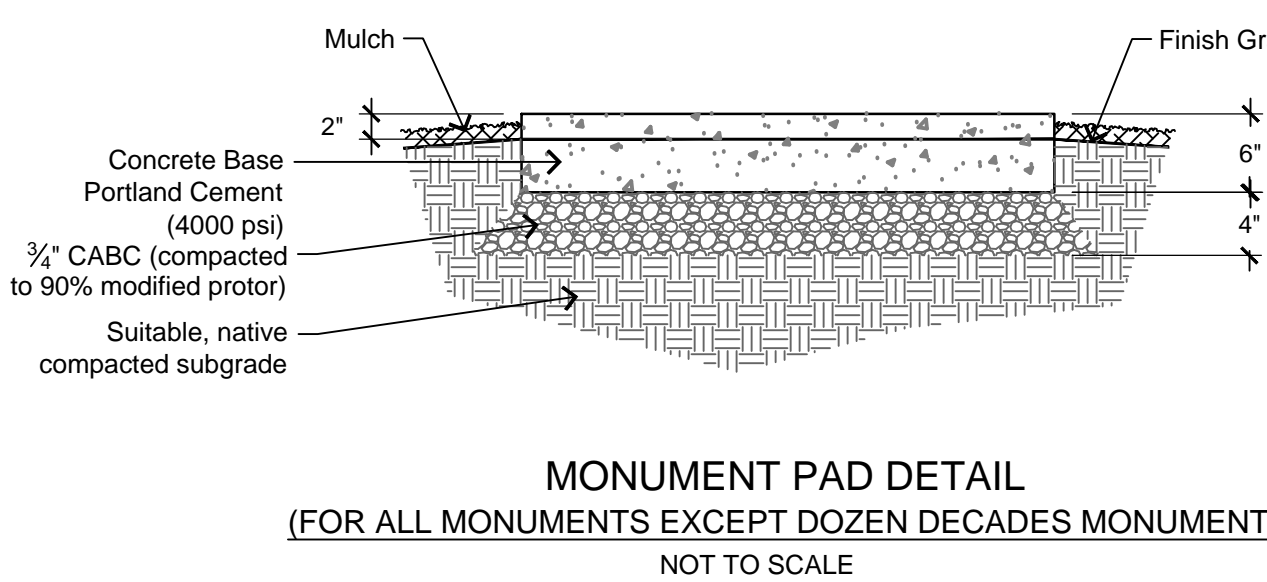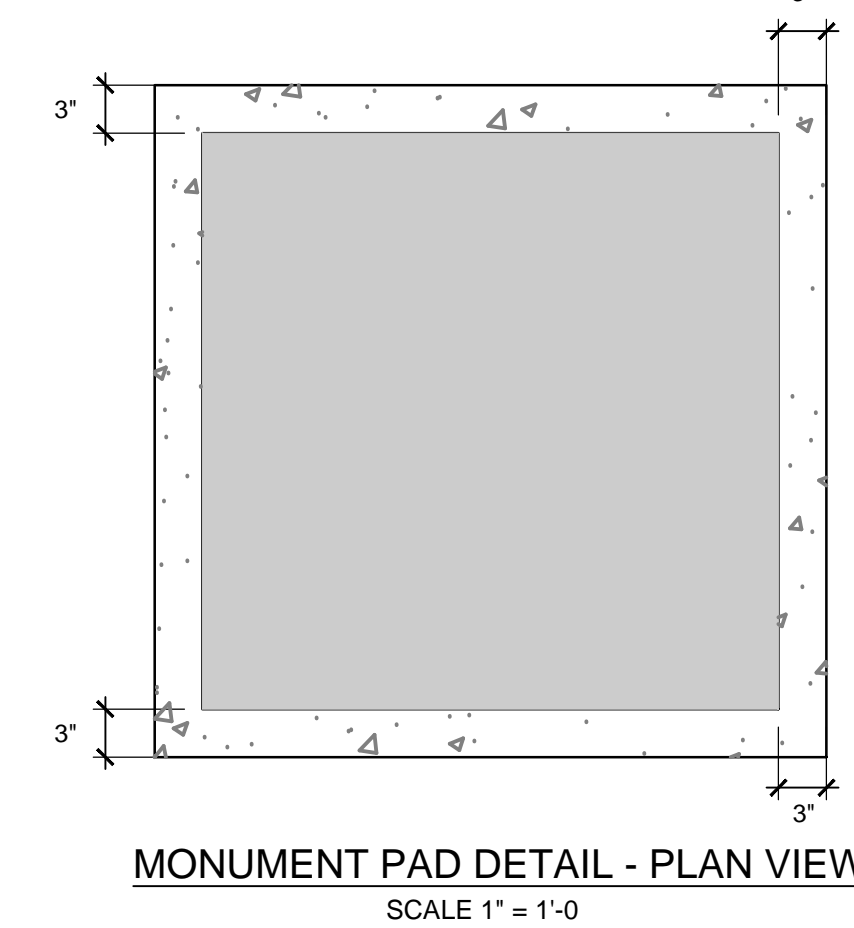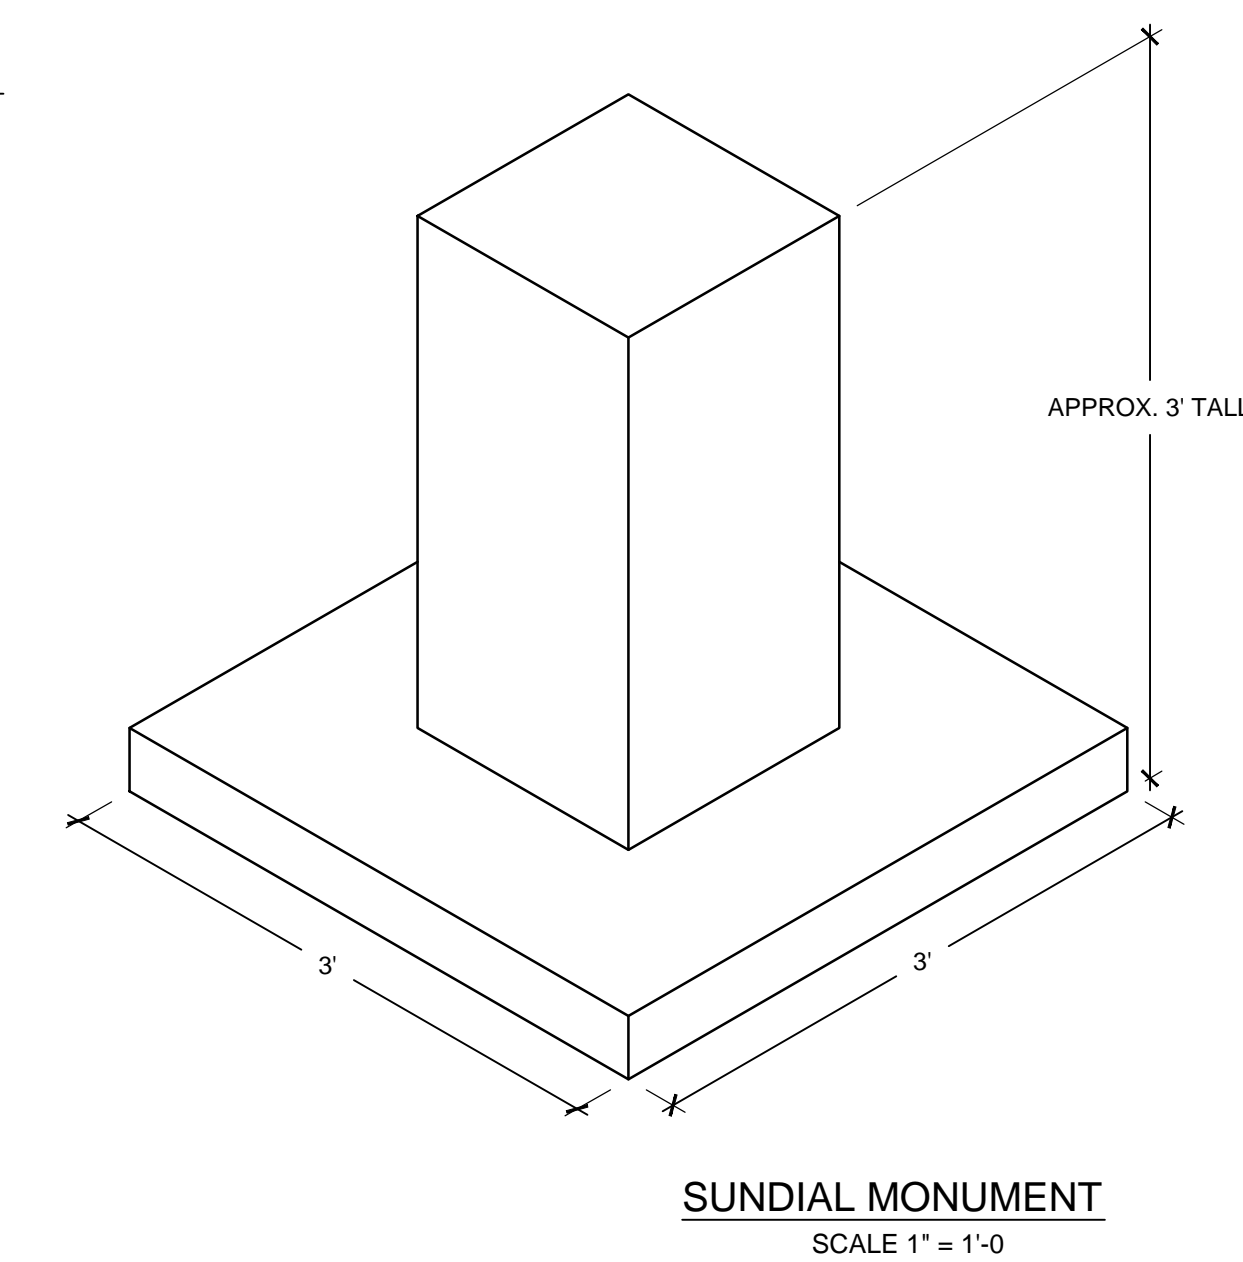

SCALE: 1" = 5'

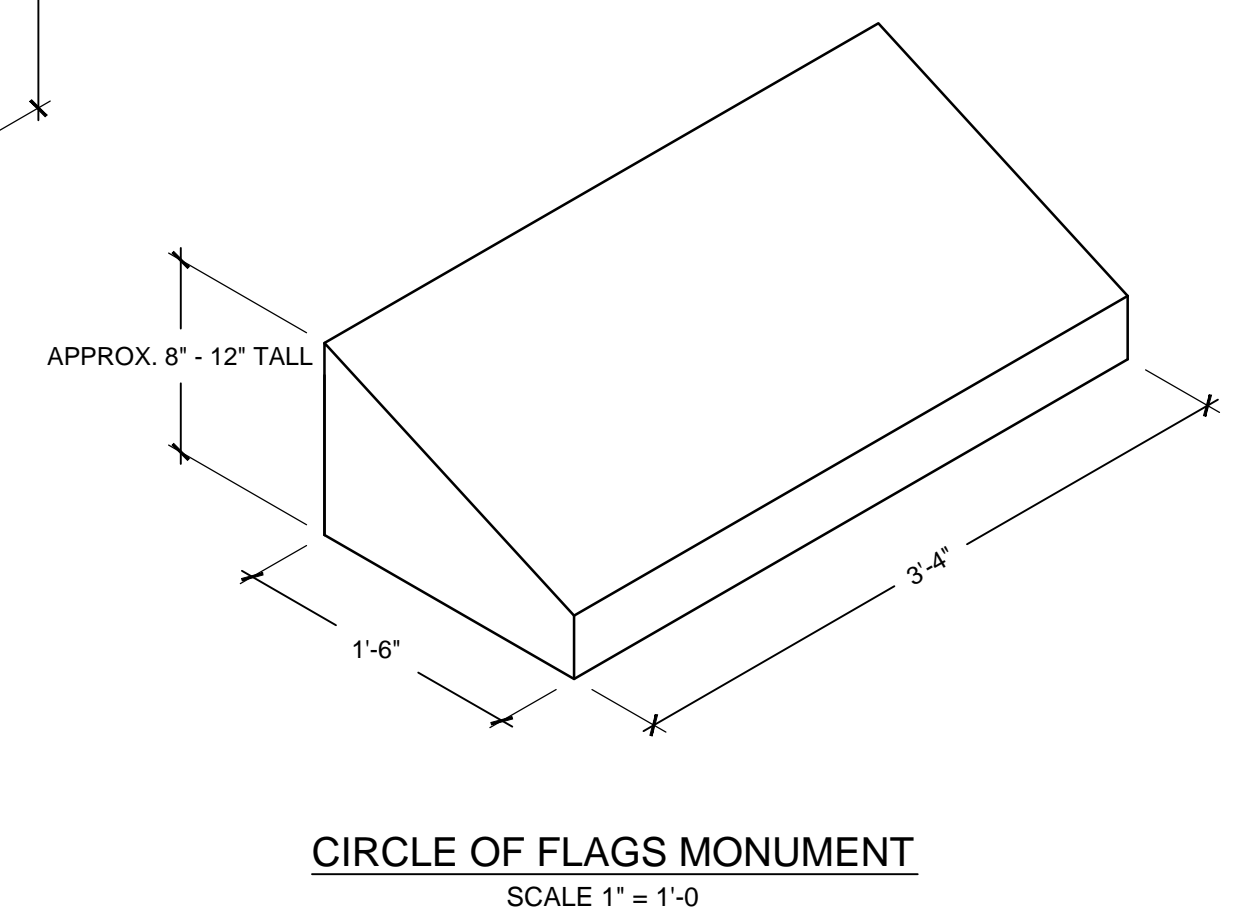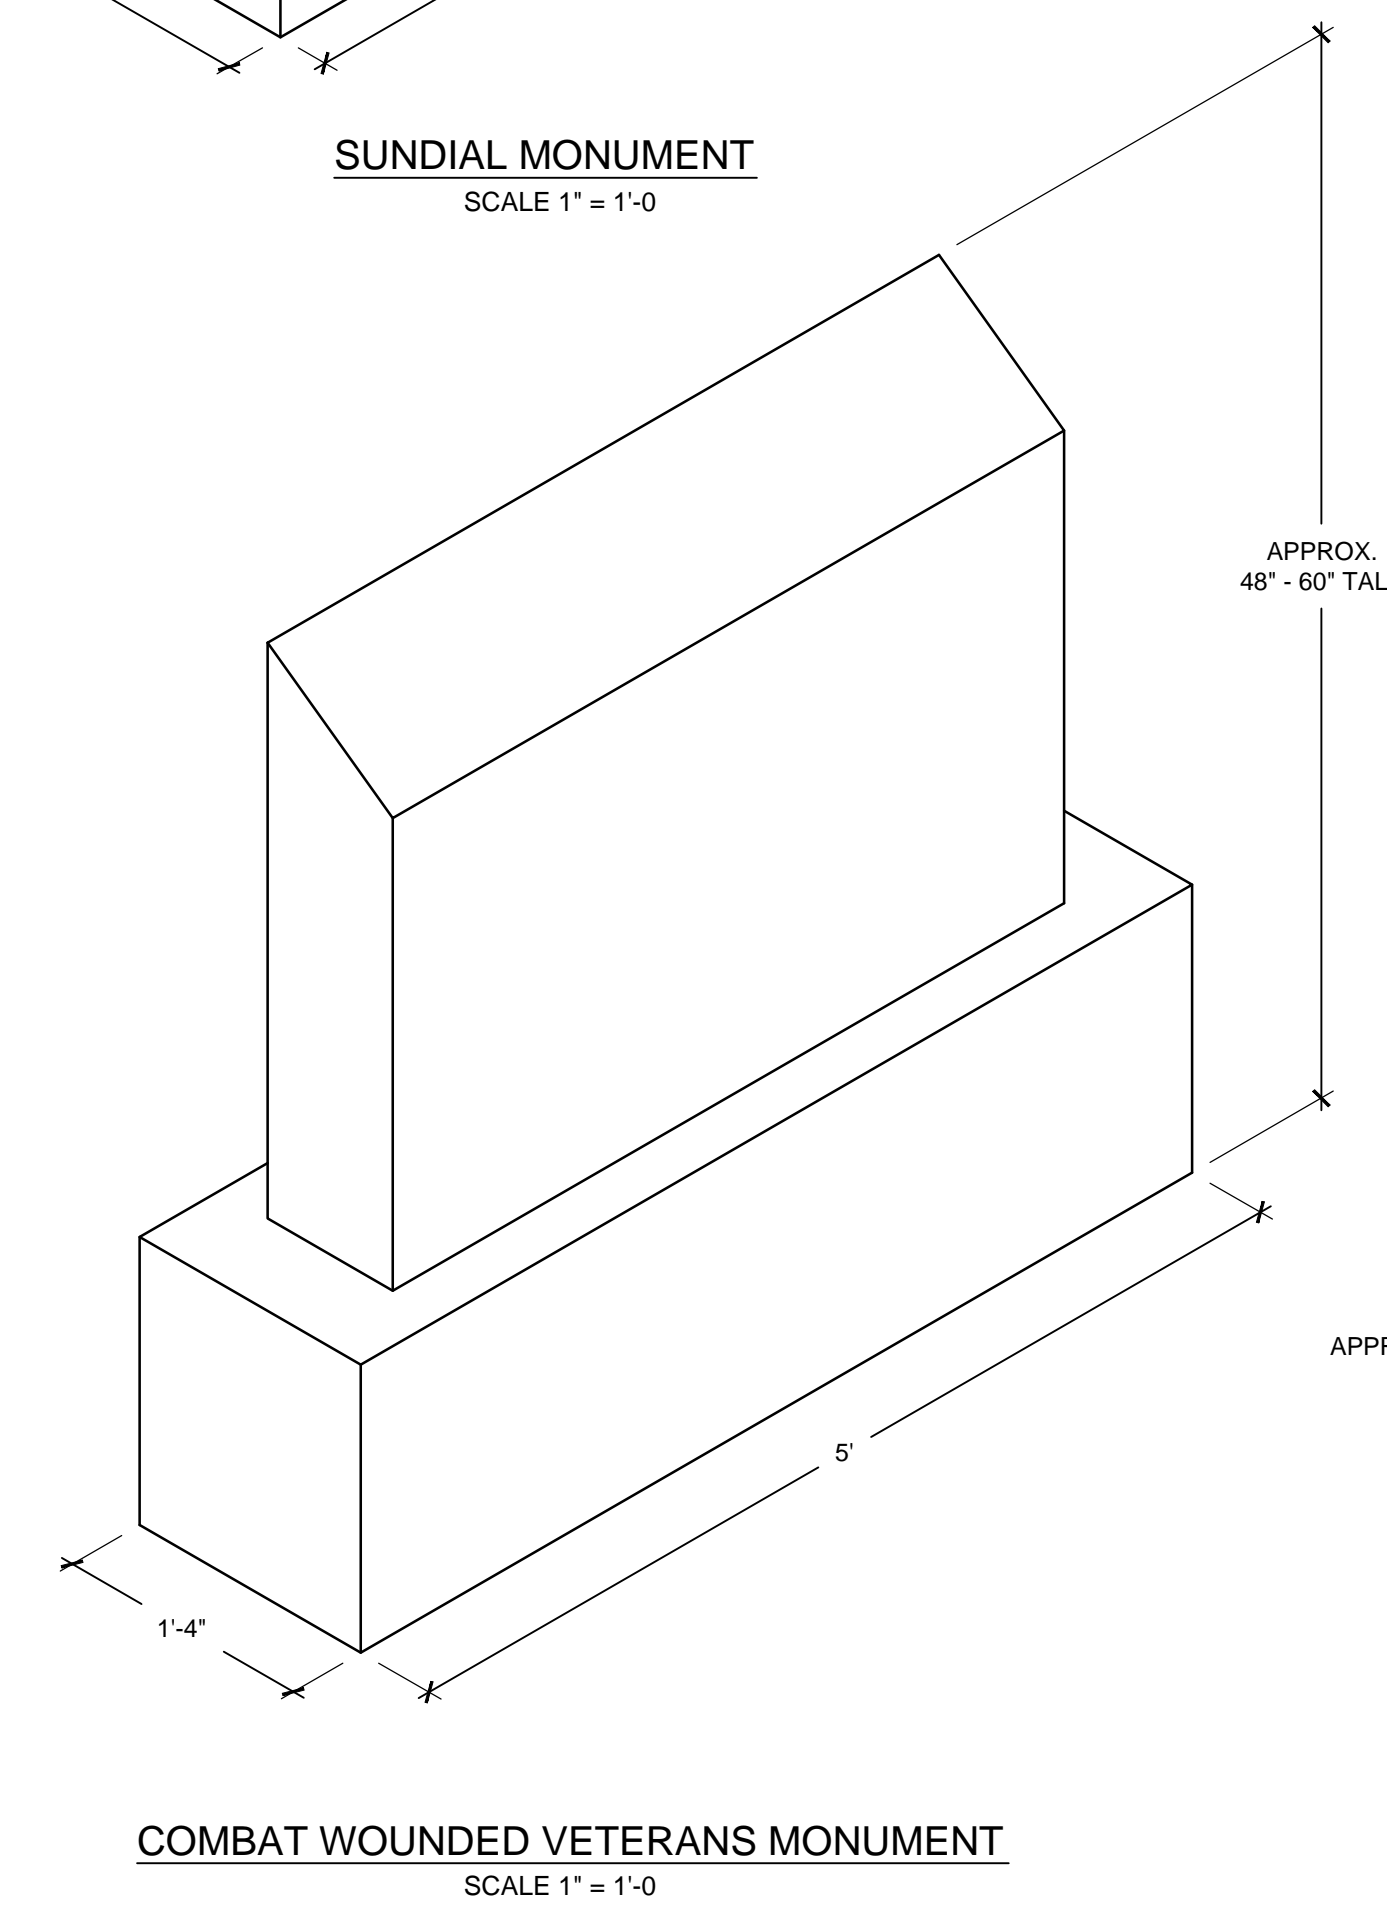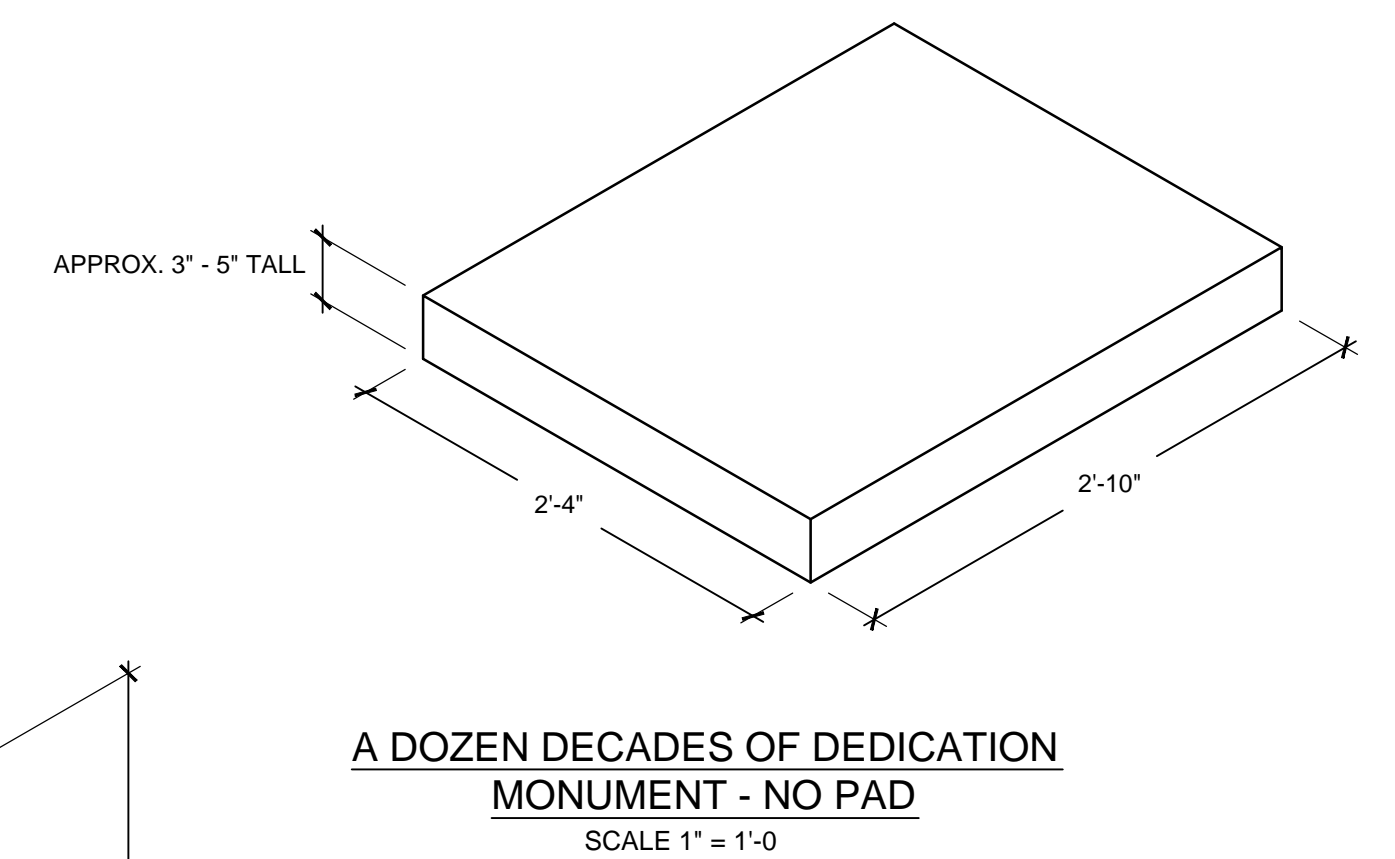[illegible]

Dept. of Veterans Affairs  
Medical Center  
5000 W. National Avenue  
Milwaukee, WI



**KEY PLAN:**

EXISTING BLDG. 111

VESTIBULE ADDITION

ENTRY CANOPY

CONSULTANTS:



PROJECT LEADER/ARCHITECT:



Drawing Title	Monument Relocation Plan & Landscape Details
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Approved: Project Director

Project Title	Building 111 - Renovate South Entry
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Location	Milwaukee, Wisconsin
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Checked By: TJM	Drawn By: ALS
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FINAL CONSTRUCTION DOCUMENTS

Project Number	695-12-101SCP
Building Number	111

Drawing Number

L103

Office of  
Facilities  
Management













